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ORIGINAL PLA	<b></b>
PECAN STREET 50' ROW	
50' ROW VOL. 112, PG. 515 B.C.D.R.	17
20.00' 50	5
VOL. 112, PG. 515 B.C.D.R.	
CERTIFICATE OF OWNERSHIP AND DEDICATION	1/2/


I, (We), \_\_\_\_\_\_\_, Owner(s) of the land shown on this plat, designated herein as Lots 1—10, Block 2 and Lots 1 and 10, Block 3, Woodlawn Addition, City of Bryan, Brazos County, Texas, in whose names are subscribed hereto, hereby dedicate to the use of the public forever all streets, alleys, parks, water courses, drains easements and public places thereon shown for the purpose and consideration therein expressed.

Notary Public In and For Brazos County, Texas

APPROVAL OF THE DEVELOPMENT ENGINEER AND PLANNING ADMINISTRATOR


We, the undersigned Development Engineer and Planning Administrator of the City of Bryan, Texas, do hereby certify that this plat is in compliance with the appropriate codes and ordinances of the City of Bryan, Texas.

Development Engineer
Planning Administrator

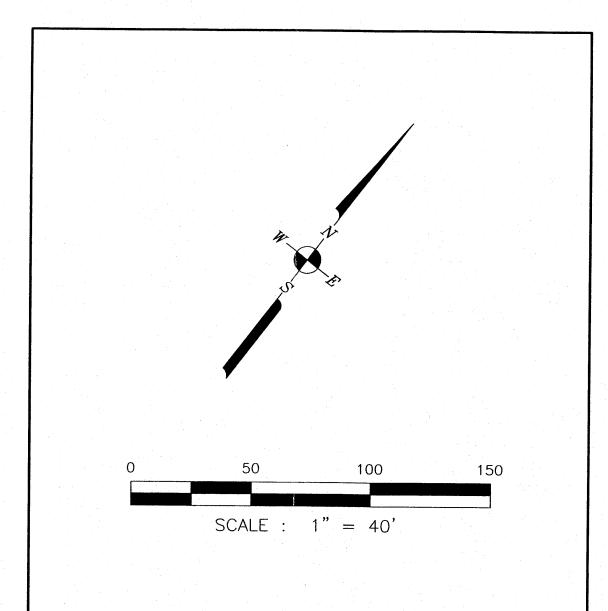

NOTES:
1. 3/8 INCH IRON RODS WITH PLASTIC CAPS STAMPED "LANDTECH CONSULTANTS" UNLESS OTHERWISE NOTED.
2. BEARINGS ARE REFERENCED TO THE TEXAS COORDINATE SYSTEM, SOUTH CENTRAL ZONE, NORTH AMERICAN DATUM OF 1983, 1993 ADJUSTMENT.
3. FLOOD ZONE NOTE HERE.

LINE TABLE BEARING DISTANCE N47°58'24"W L2 N42°01'36"E L3 S47°58'24"E 50.00' 10.00' N42°01'36"W 50.00' N42°01'36"E 60.00' S42'01'36"W 60.00' N42'01'36"E 65.00' N42°01'36"W 65.00' N42'01'36"E 150.00' L10 S42'01'36"W 150.00 N42°01'36"E 125.00' L12 N42\*01'36"W 125.00' L13 N42°01'36"E 40.00' L14 S42°01'36"W 40.00' N42'01'36"E 60.00' L16 N42'01'36"W 60.00'

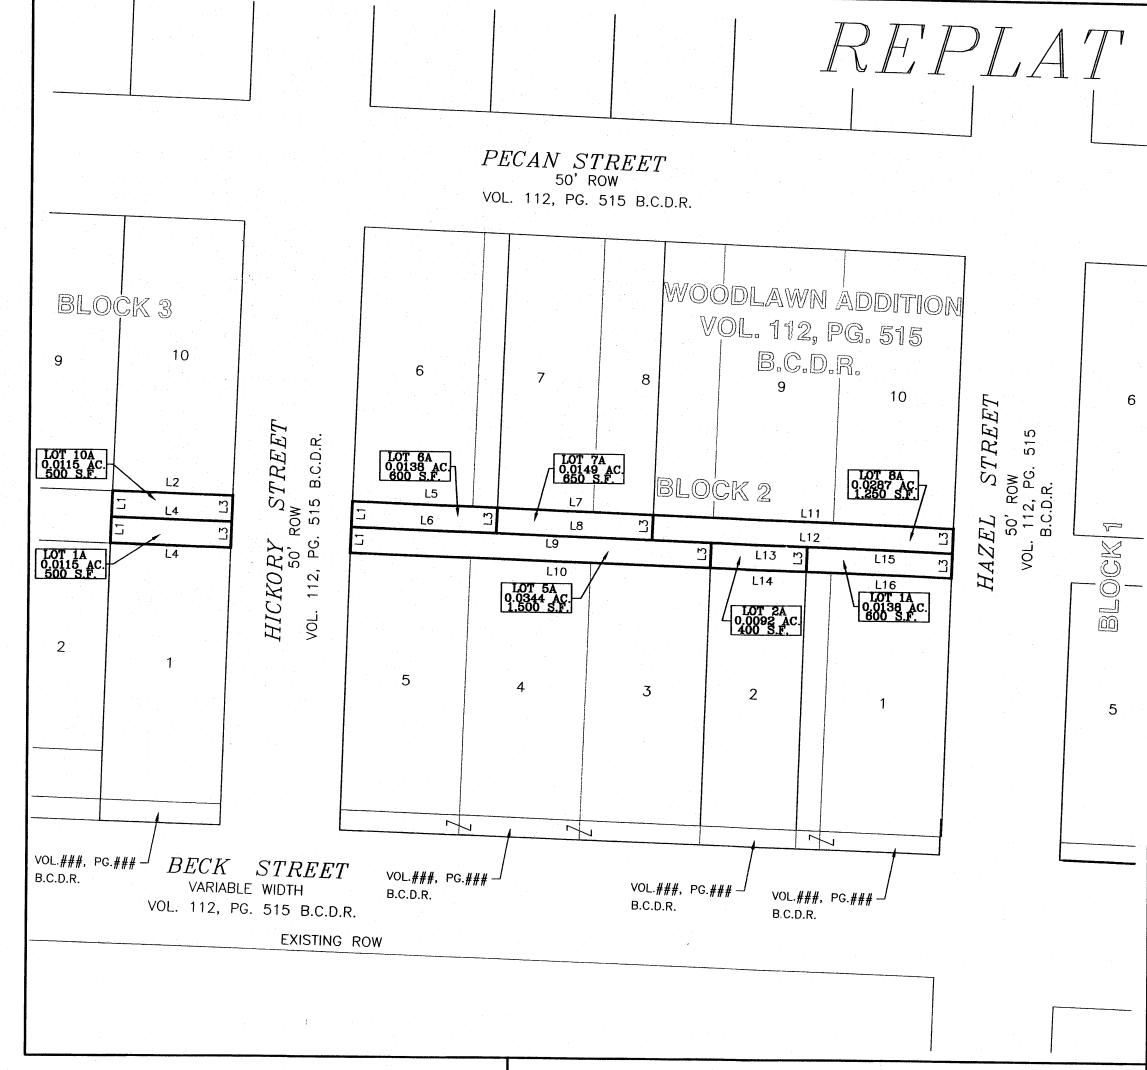

## CERTIFICATION OF THE COUNTY CLERK


STATE OF TEXAS
COUNTY OF BRAZOS
I, Mary Ann Ward, County Clerk in and for said County, do hereby certify that this plat together with its certificates of arthentication was filed for record in my office the \_\_\_\_\_\_day of \_\_\_\_\_\_\_, 1997, in the Official Public Records of Brazos County Texas, in Volume \_\_\_\_\_\_, Page \_\_\_\_\_\_.

CERTIFICATION OF THE PLANNING AND ZONING CHAIRMAN

l,\_\_\_\_\_\_\_, Chairman of the City Planning and Zoning Commission of the City of Bryan, State of Texas, hereby certify that the attached plat was duly filed for approval with the City Planning and Zoning Commission of the City of Bryan on the \_\_\_\_\_\_ day of \_\_\_\_\_\_\_, 1997 by said Commission.

Chairman, City Planning and Zoning Cimmission

County Clerk

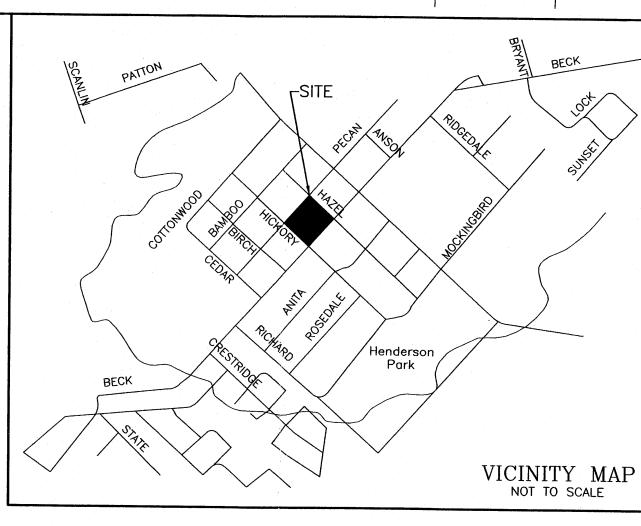

CERTIFICATION OF SURVEYOR

STATE OF TEXAS
COUNTY OF BRAZOS

I, Douglas W. Turner, a Registerd Professional Land Surveyor of the State of Texas do hereby certify that this plat was prepared from an actual survey of the property.

Douglas W. Turner, R.P.L.S.

REPLAT OF LOTS 1-10, BLOCK 2 AND LOTS 1 & 10, BLOCK 3 OF WOODLAWN ADDITION, VOLUME 112, PAGE 515 BRAZOS COUNTY DEED RECORDS FEB 8 2006

CH CONSULTANT

LANDTECH CONSULTANTS, INC.

Civil Engineering \* Land Surveying

2627 North Loop West

Suite 224

Houston, Texas 77008


Tel. (713) 861-7068 Fax (713) 861-4


DATE: June 24, 2006


SCALE: 1" = 50'
DRAWING No.: 0000

JOB No.: 0410168


SHEET No.: 1 OF 1

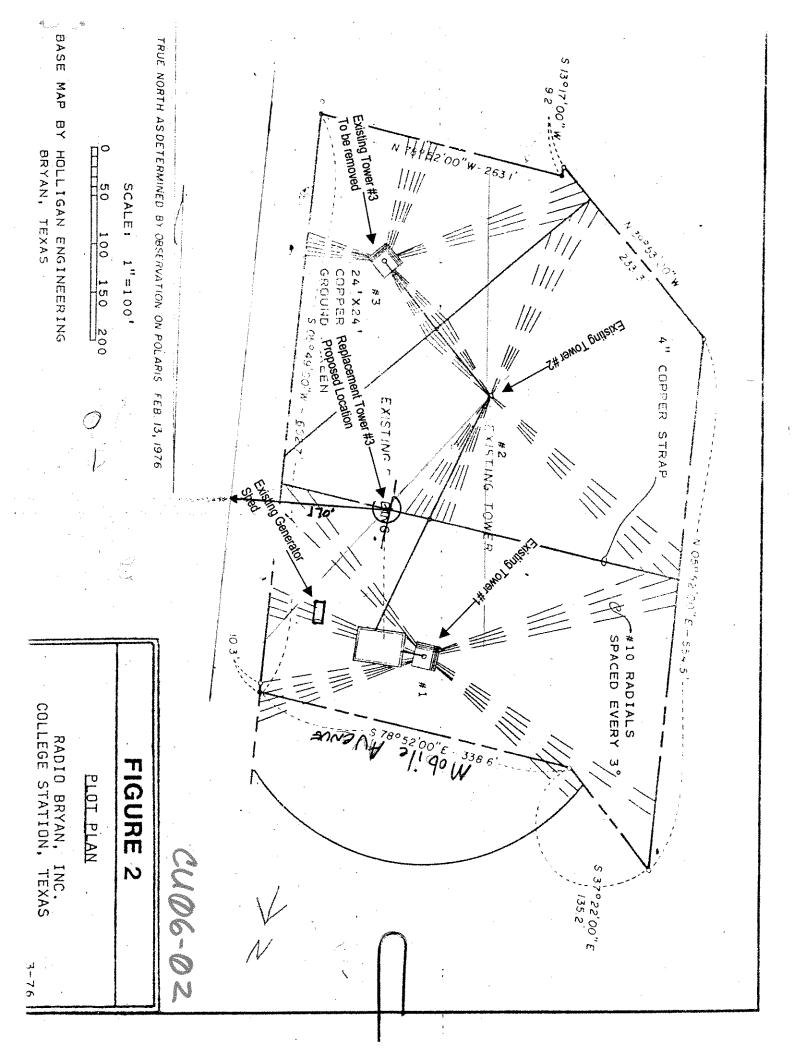


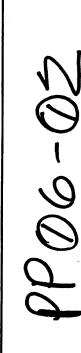


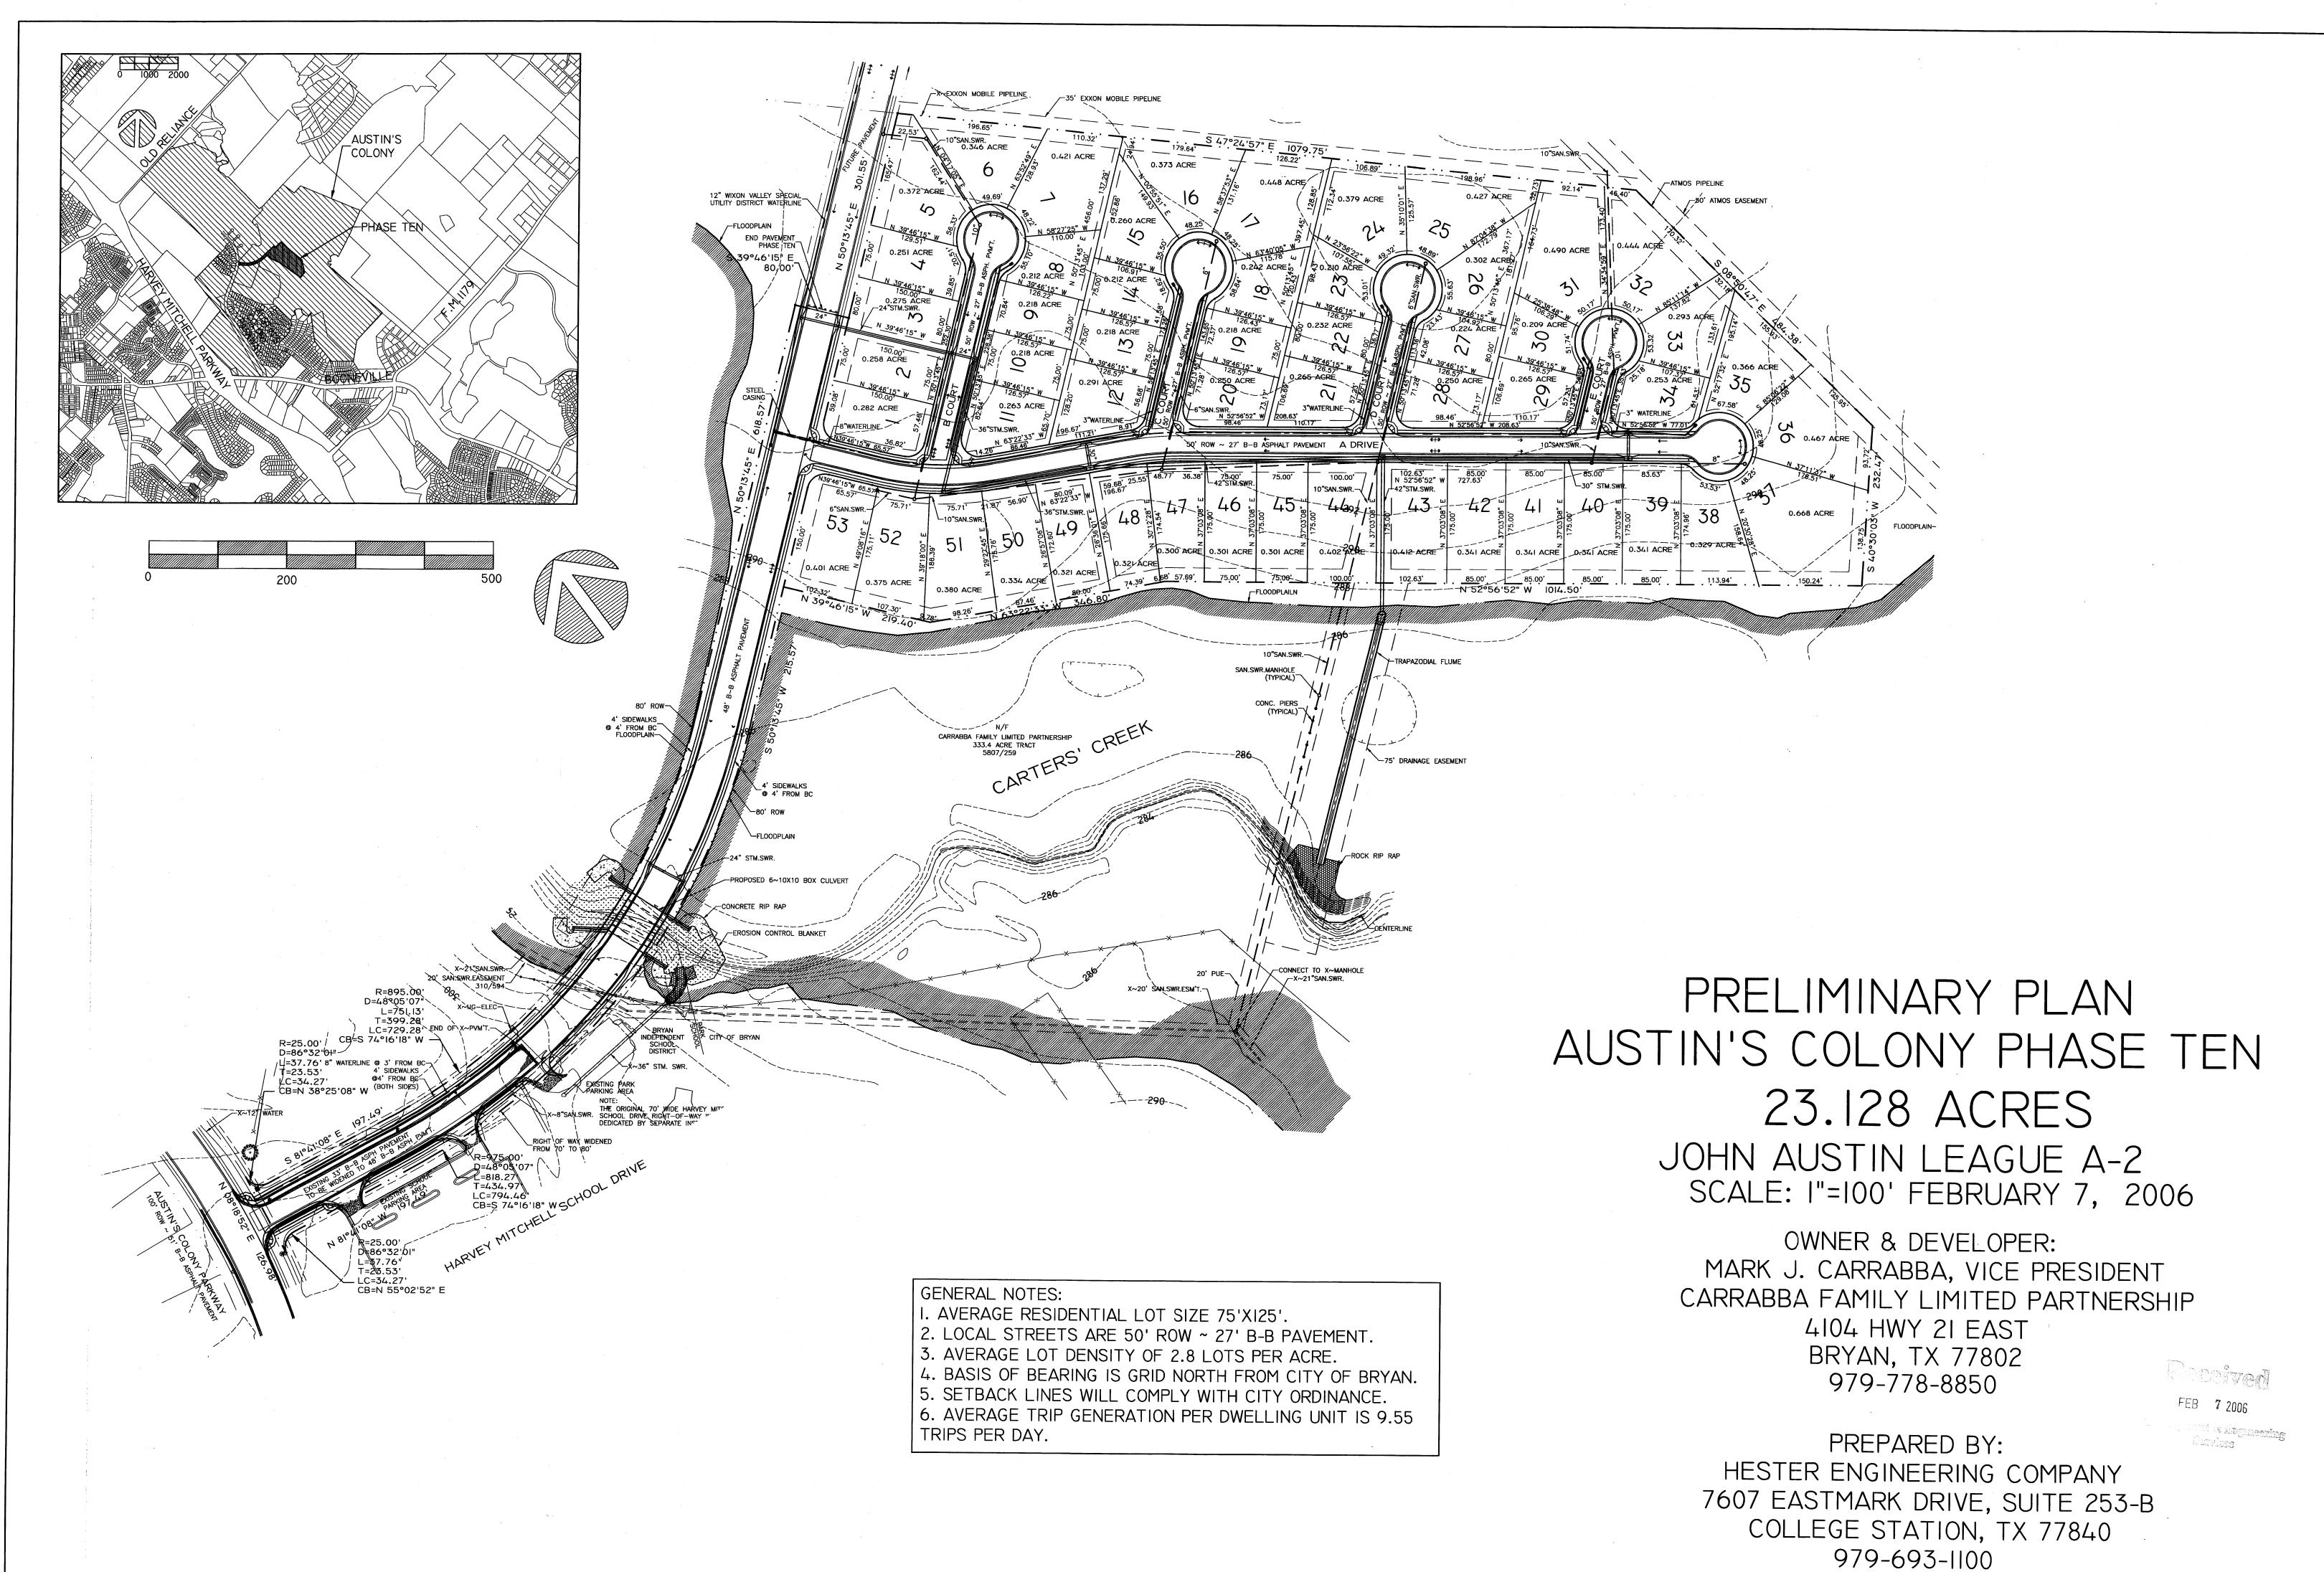


P06-03

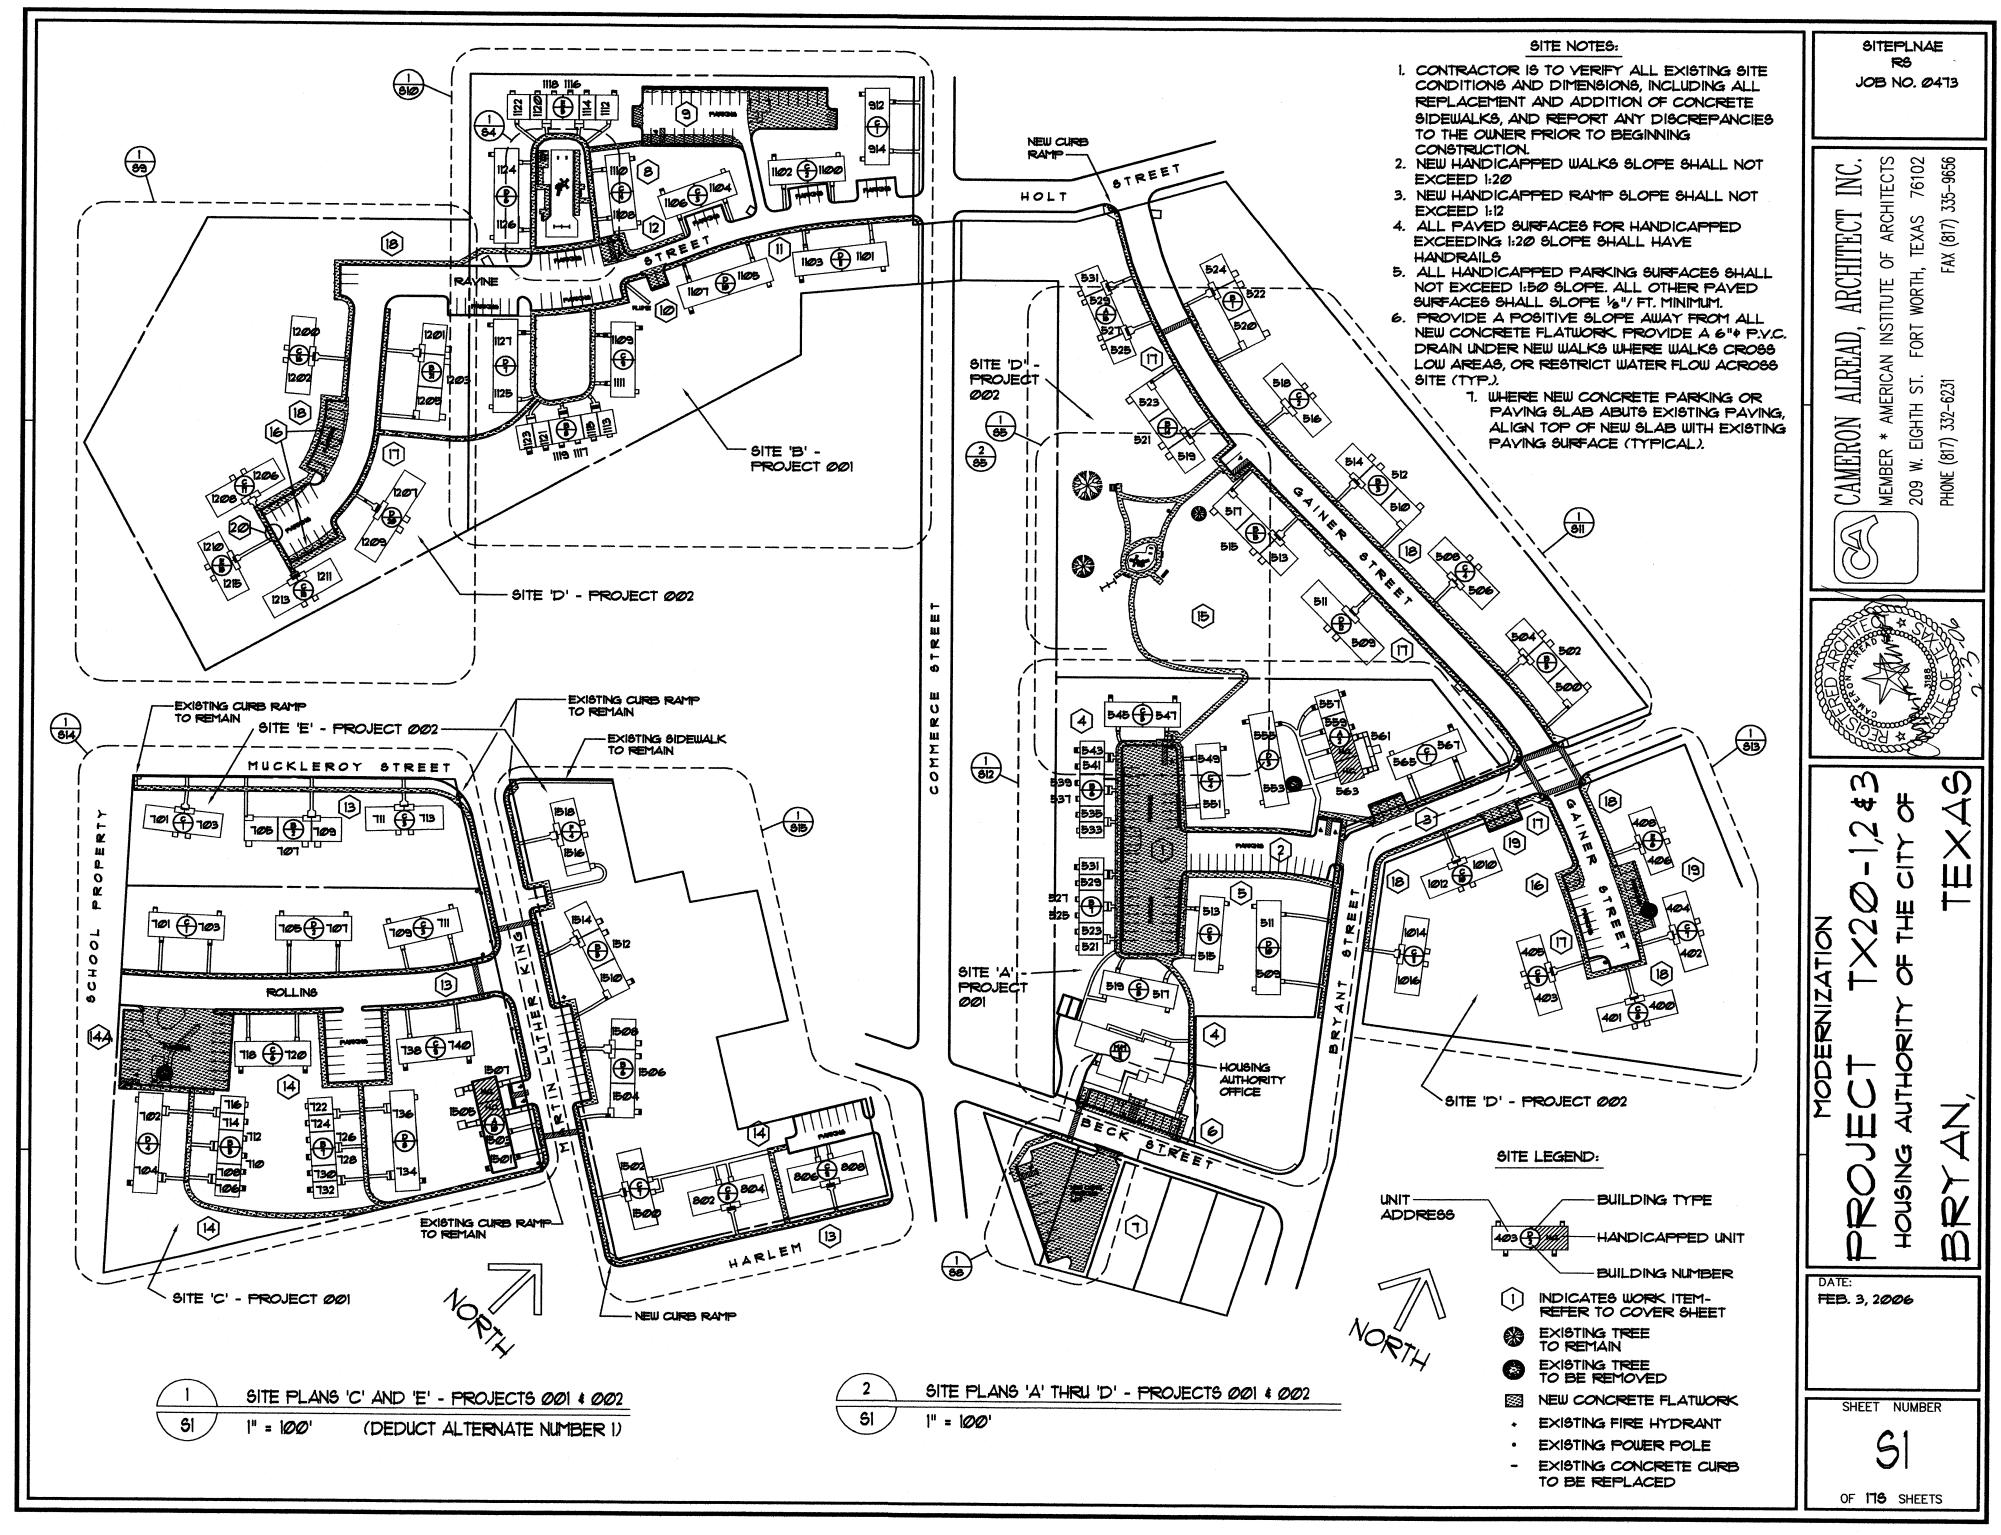

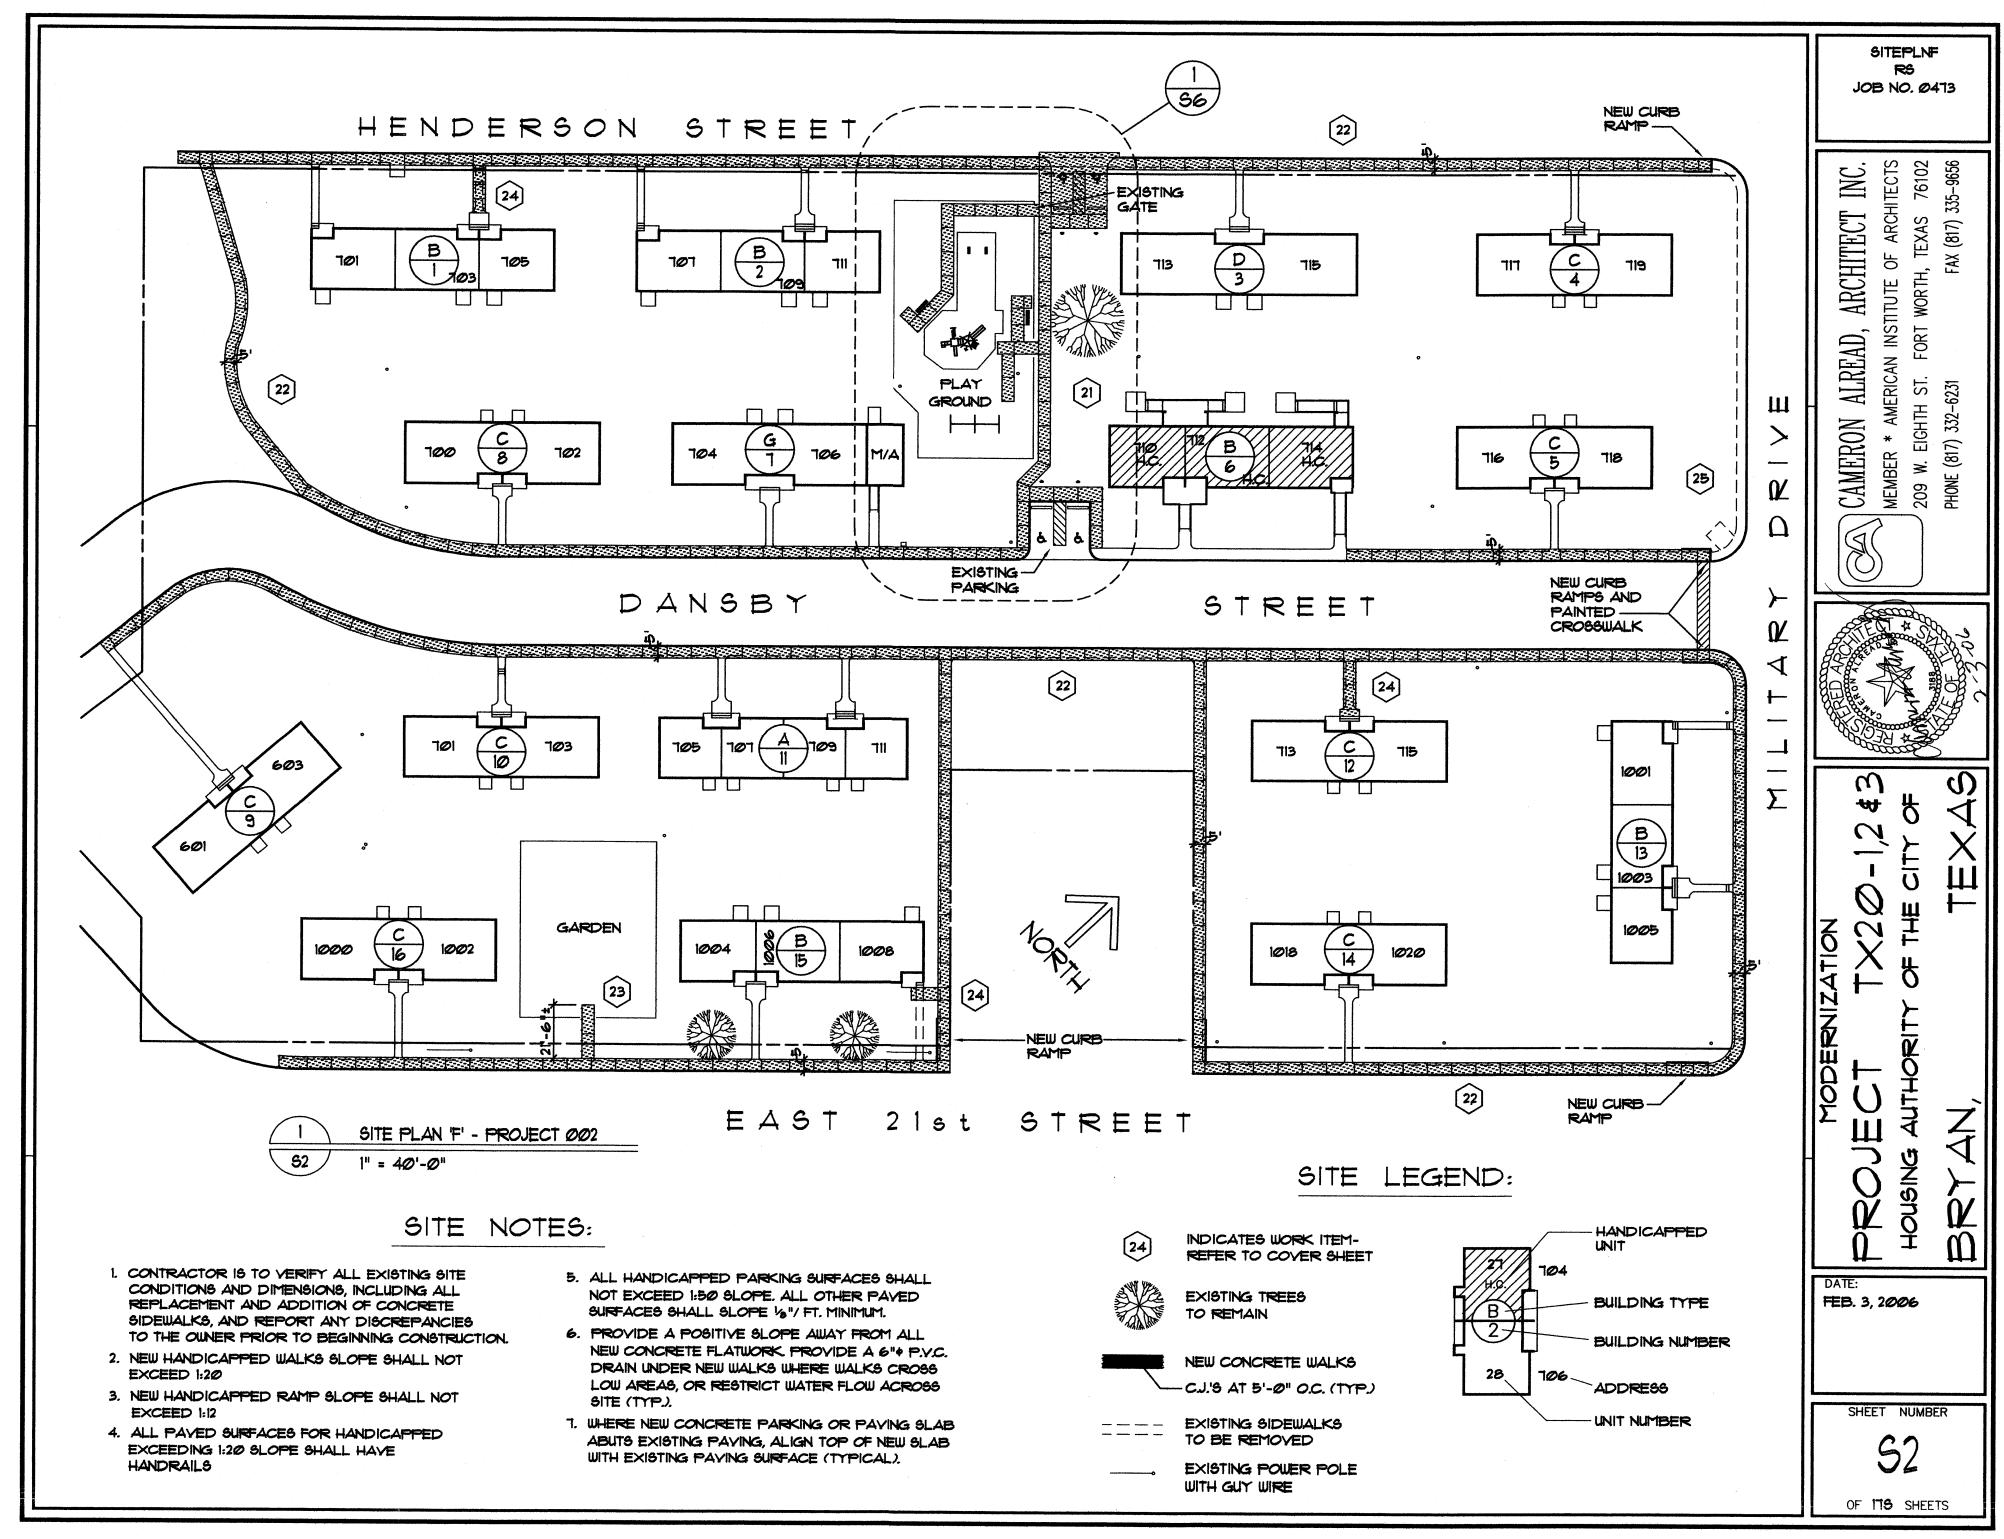

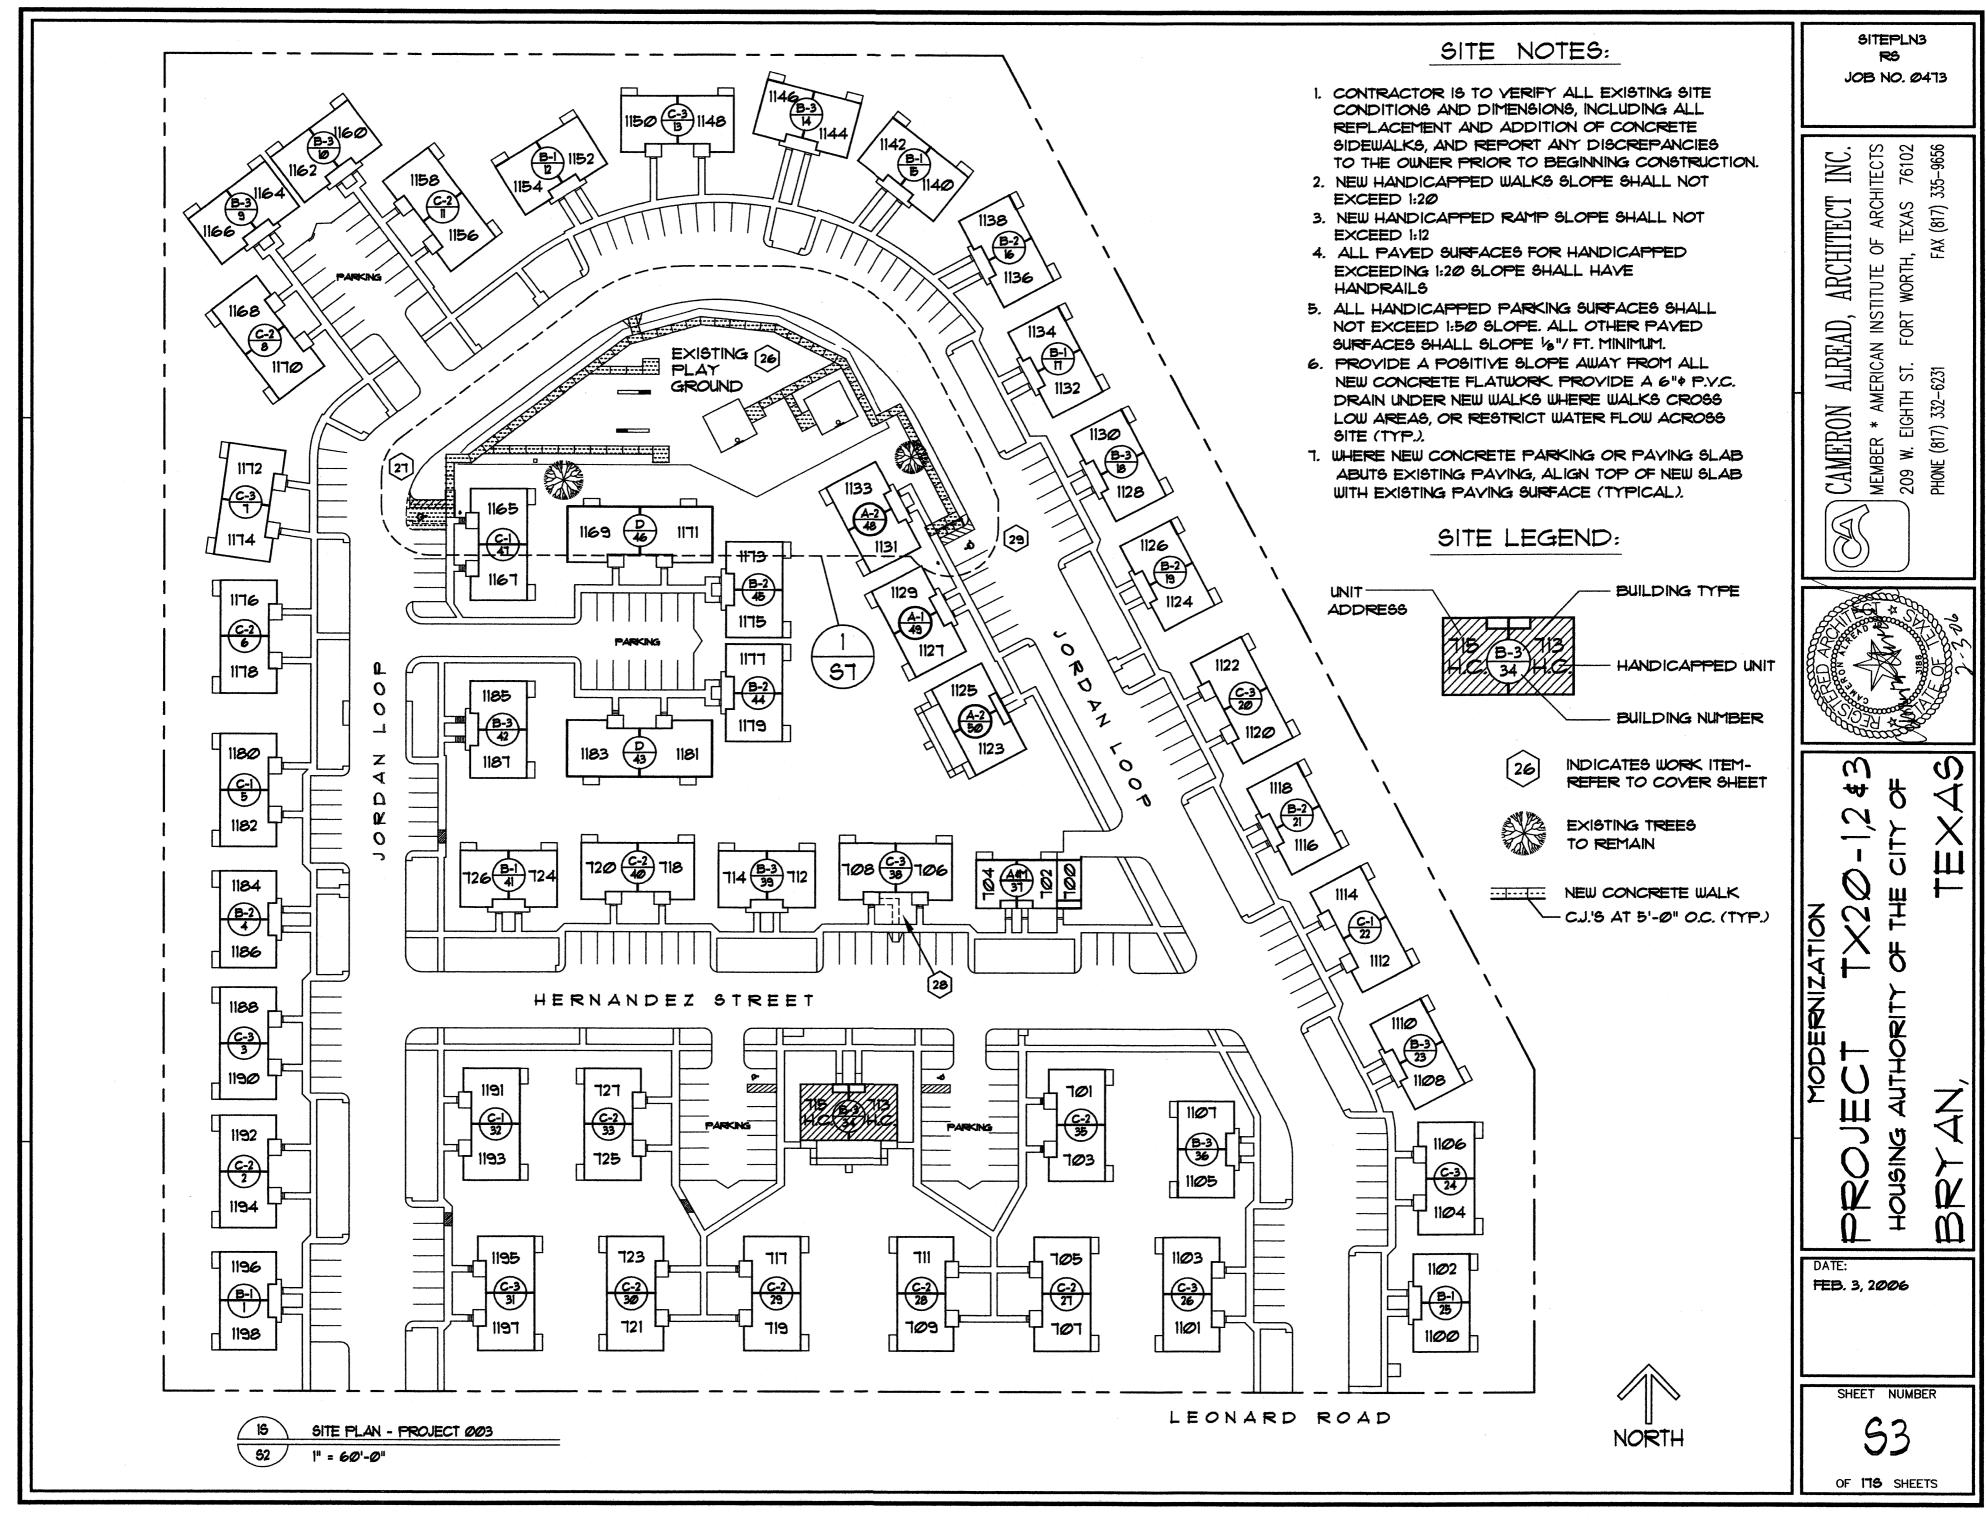


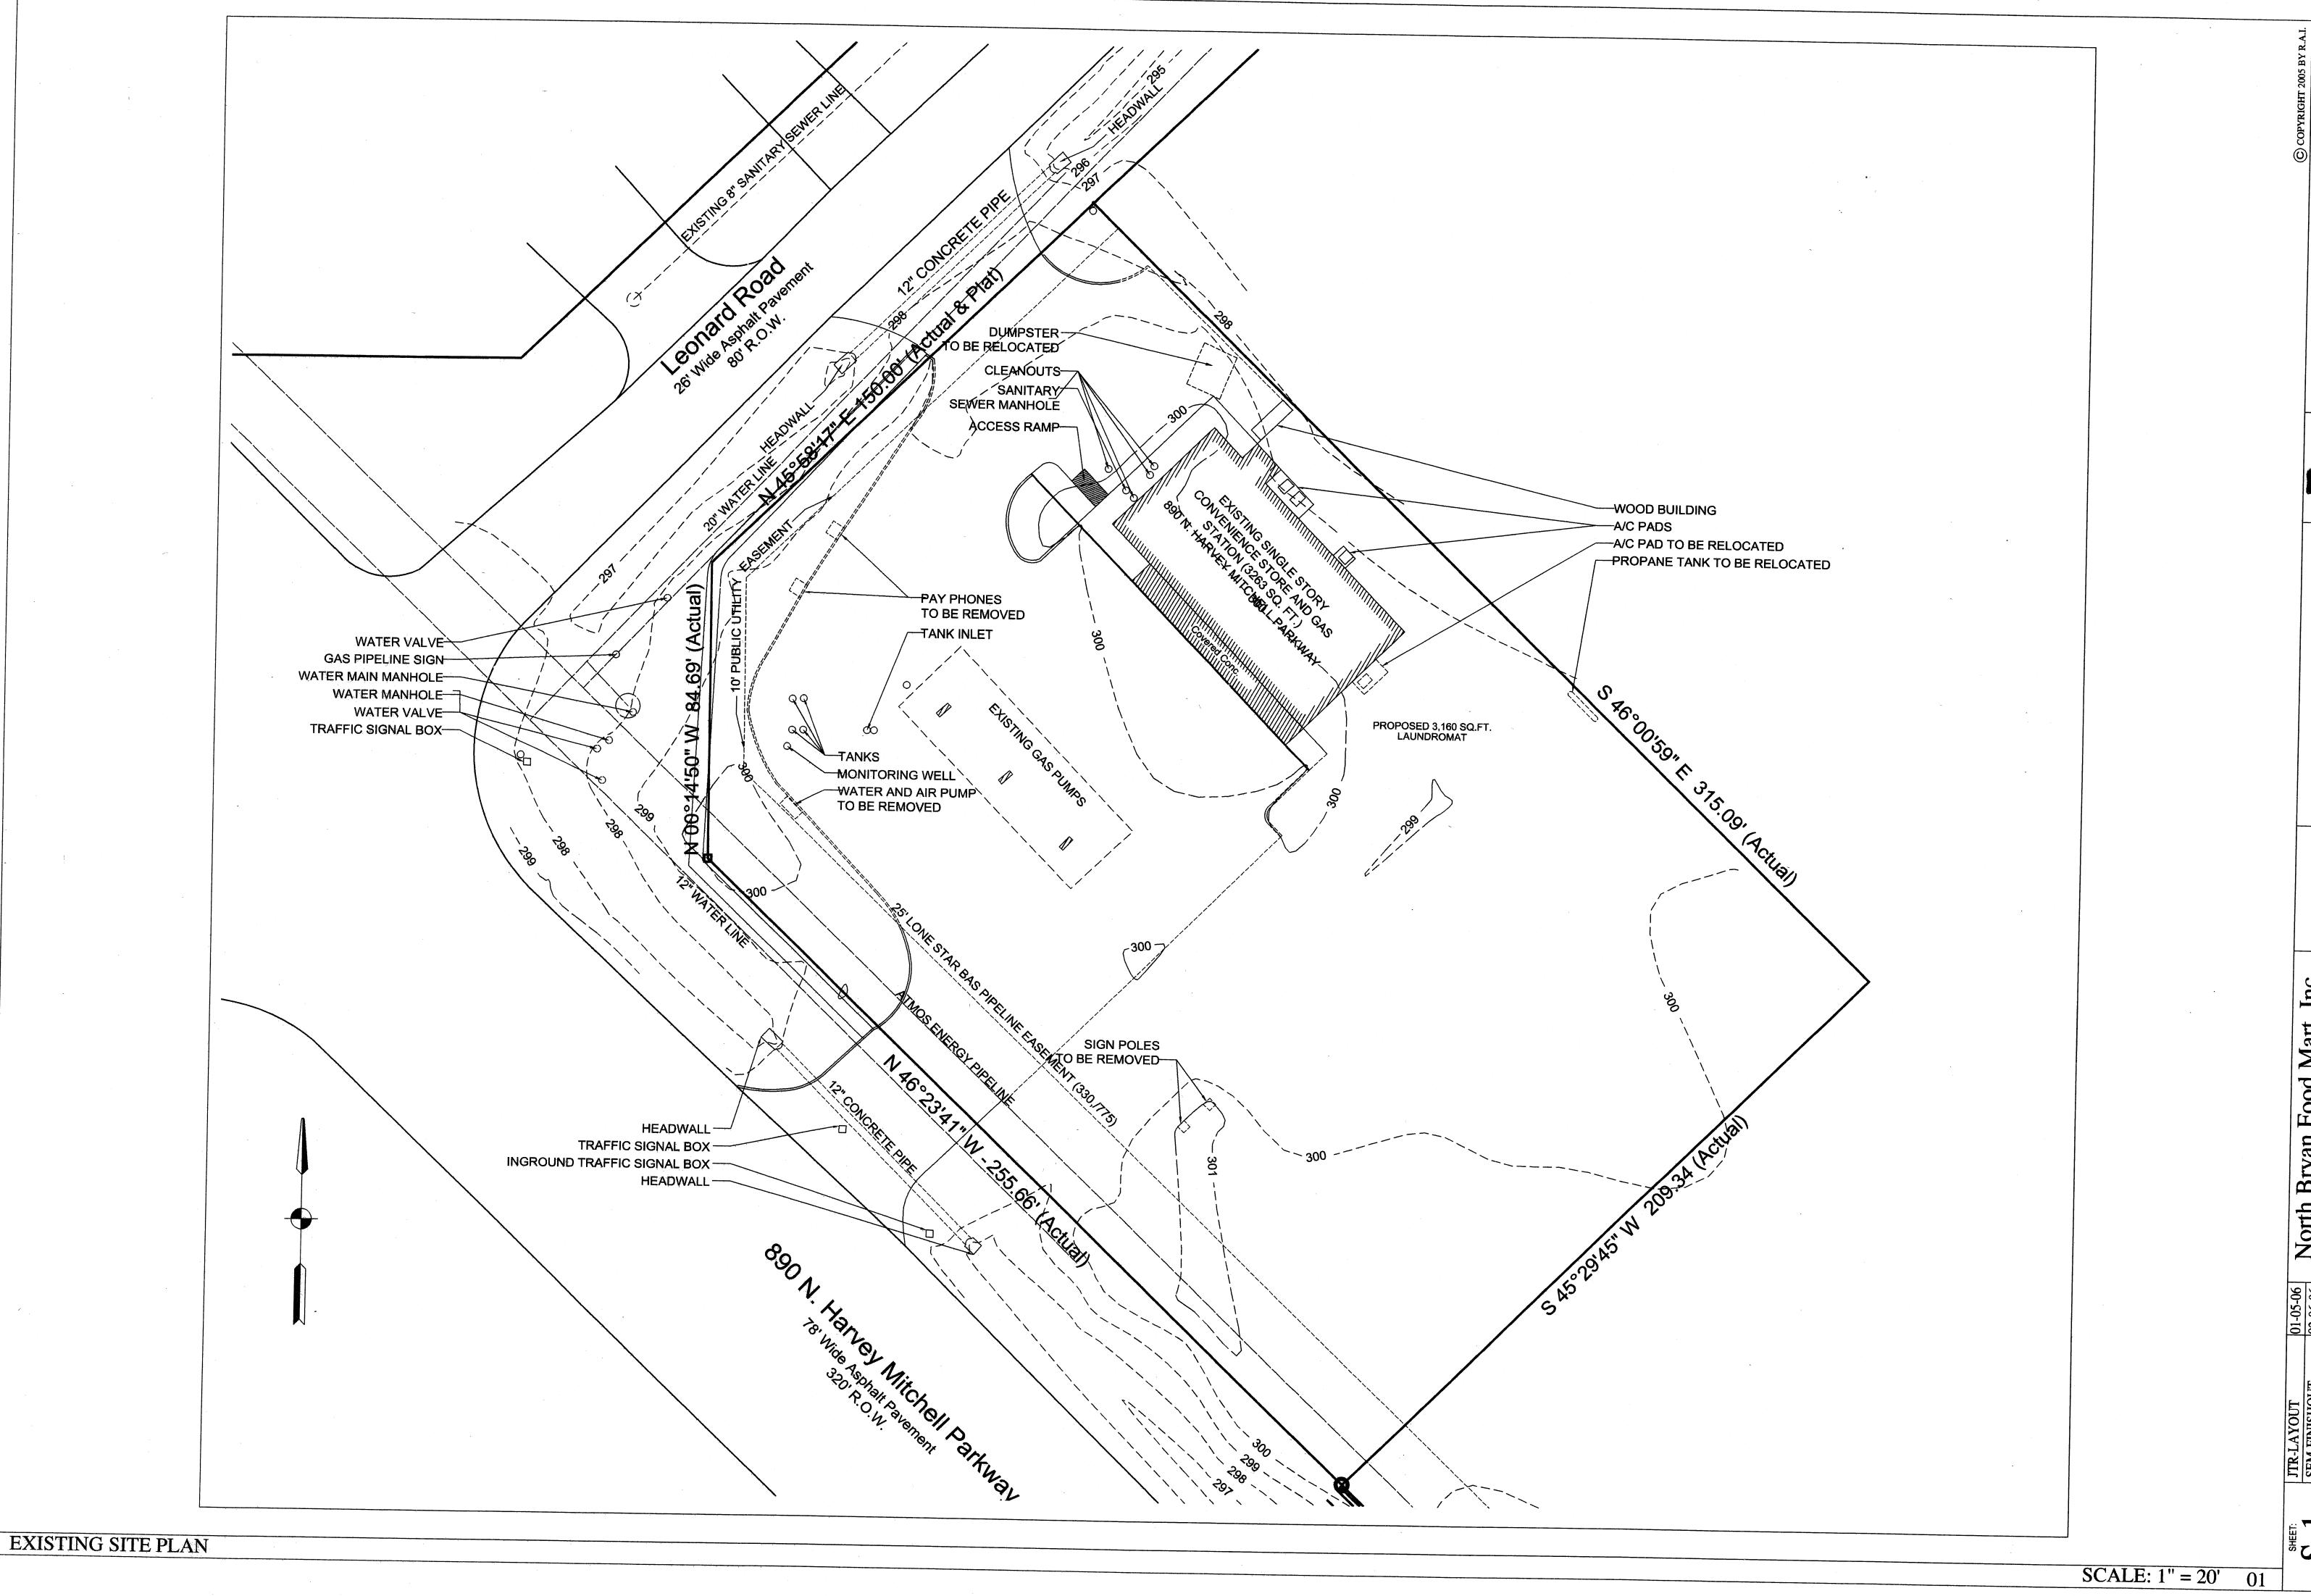


(979)-846-3366 4500 Carter Creek Dr. #20 Bryan, TX 77802 www.raidesigns.com

NORTH BRYAN
FOOD MART
ADDITION & CARWASH

North Bryan Food Mart, Inc.
P.O. Box 4650
Bryan, TX 77805
(979) 575-4545

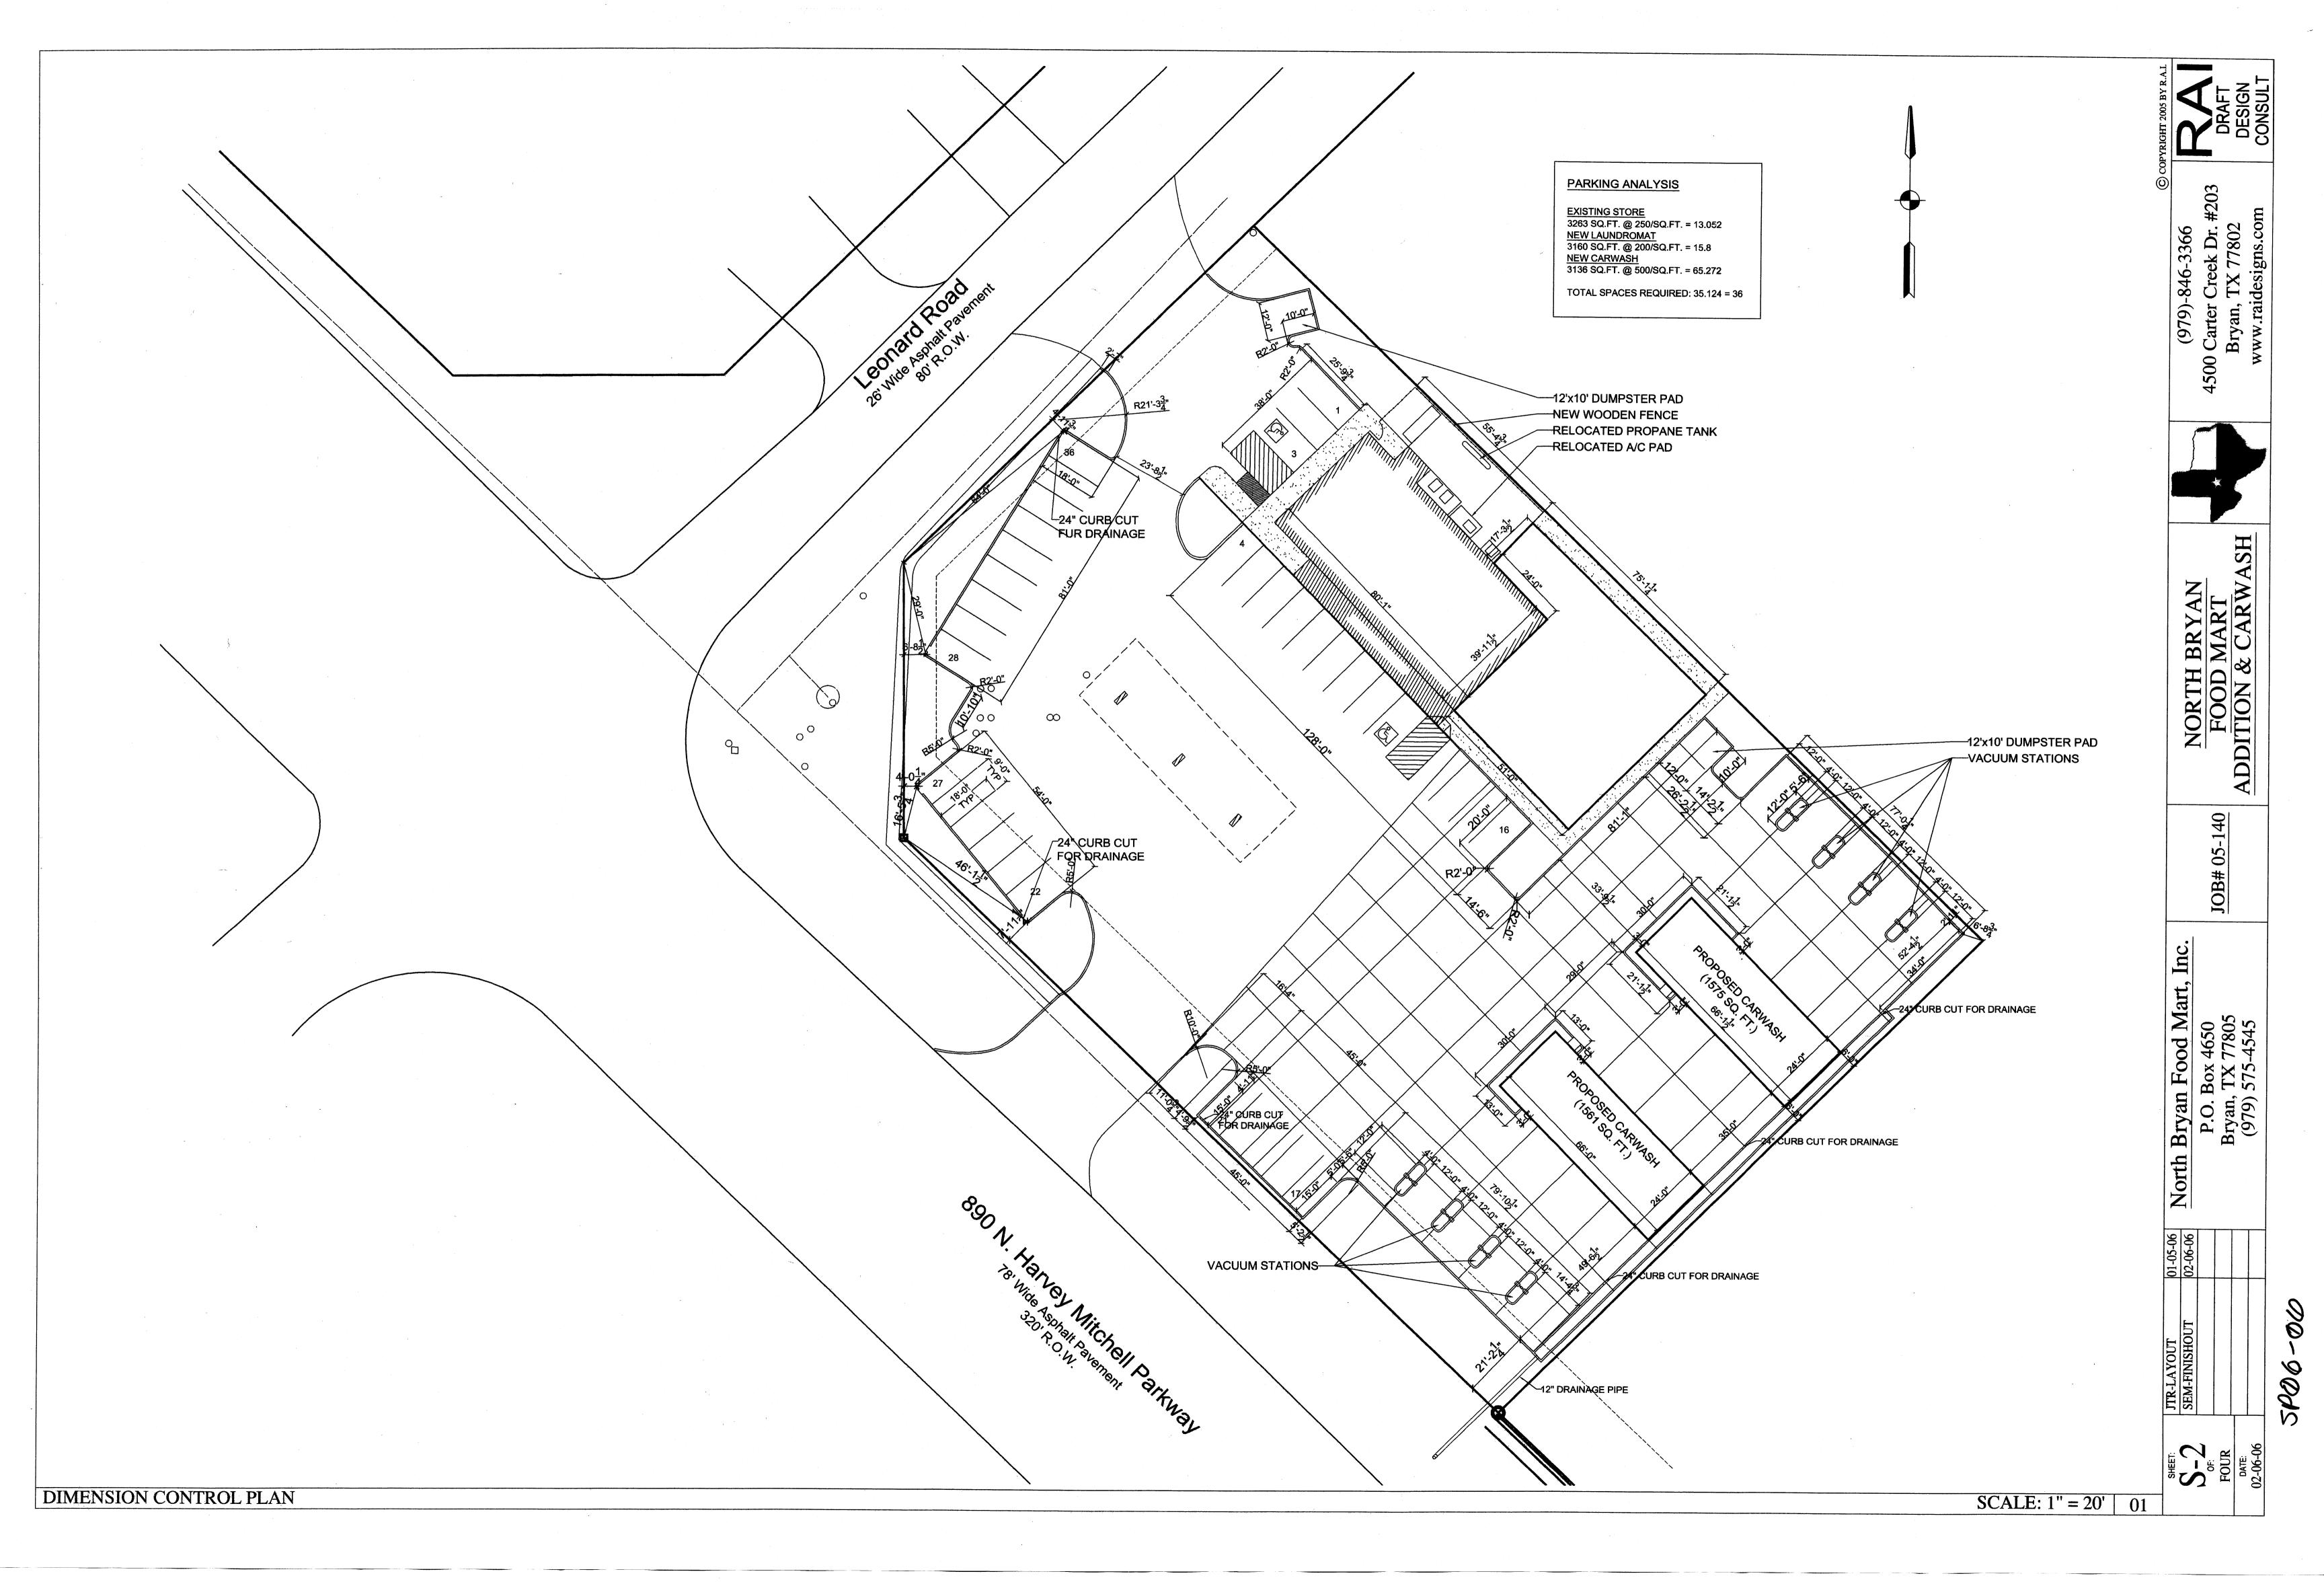

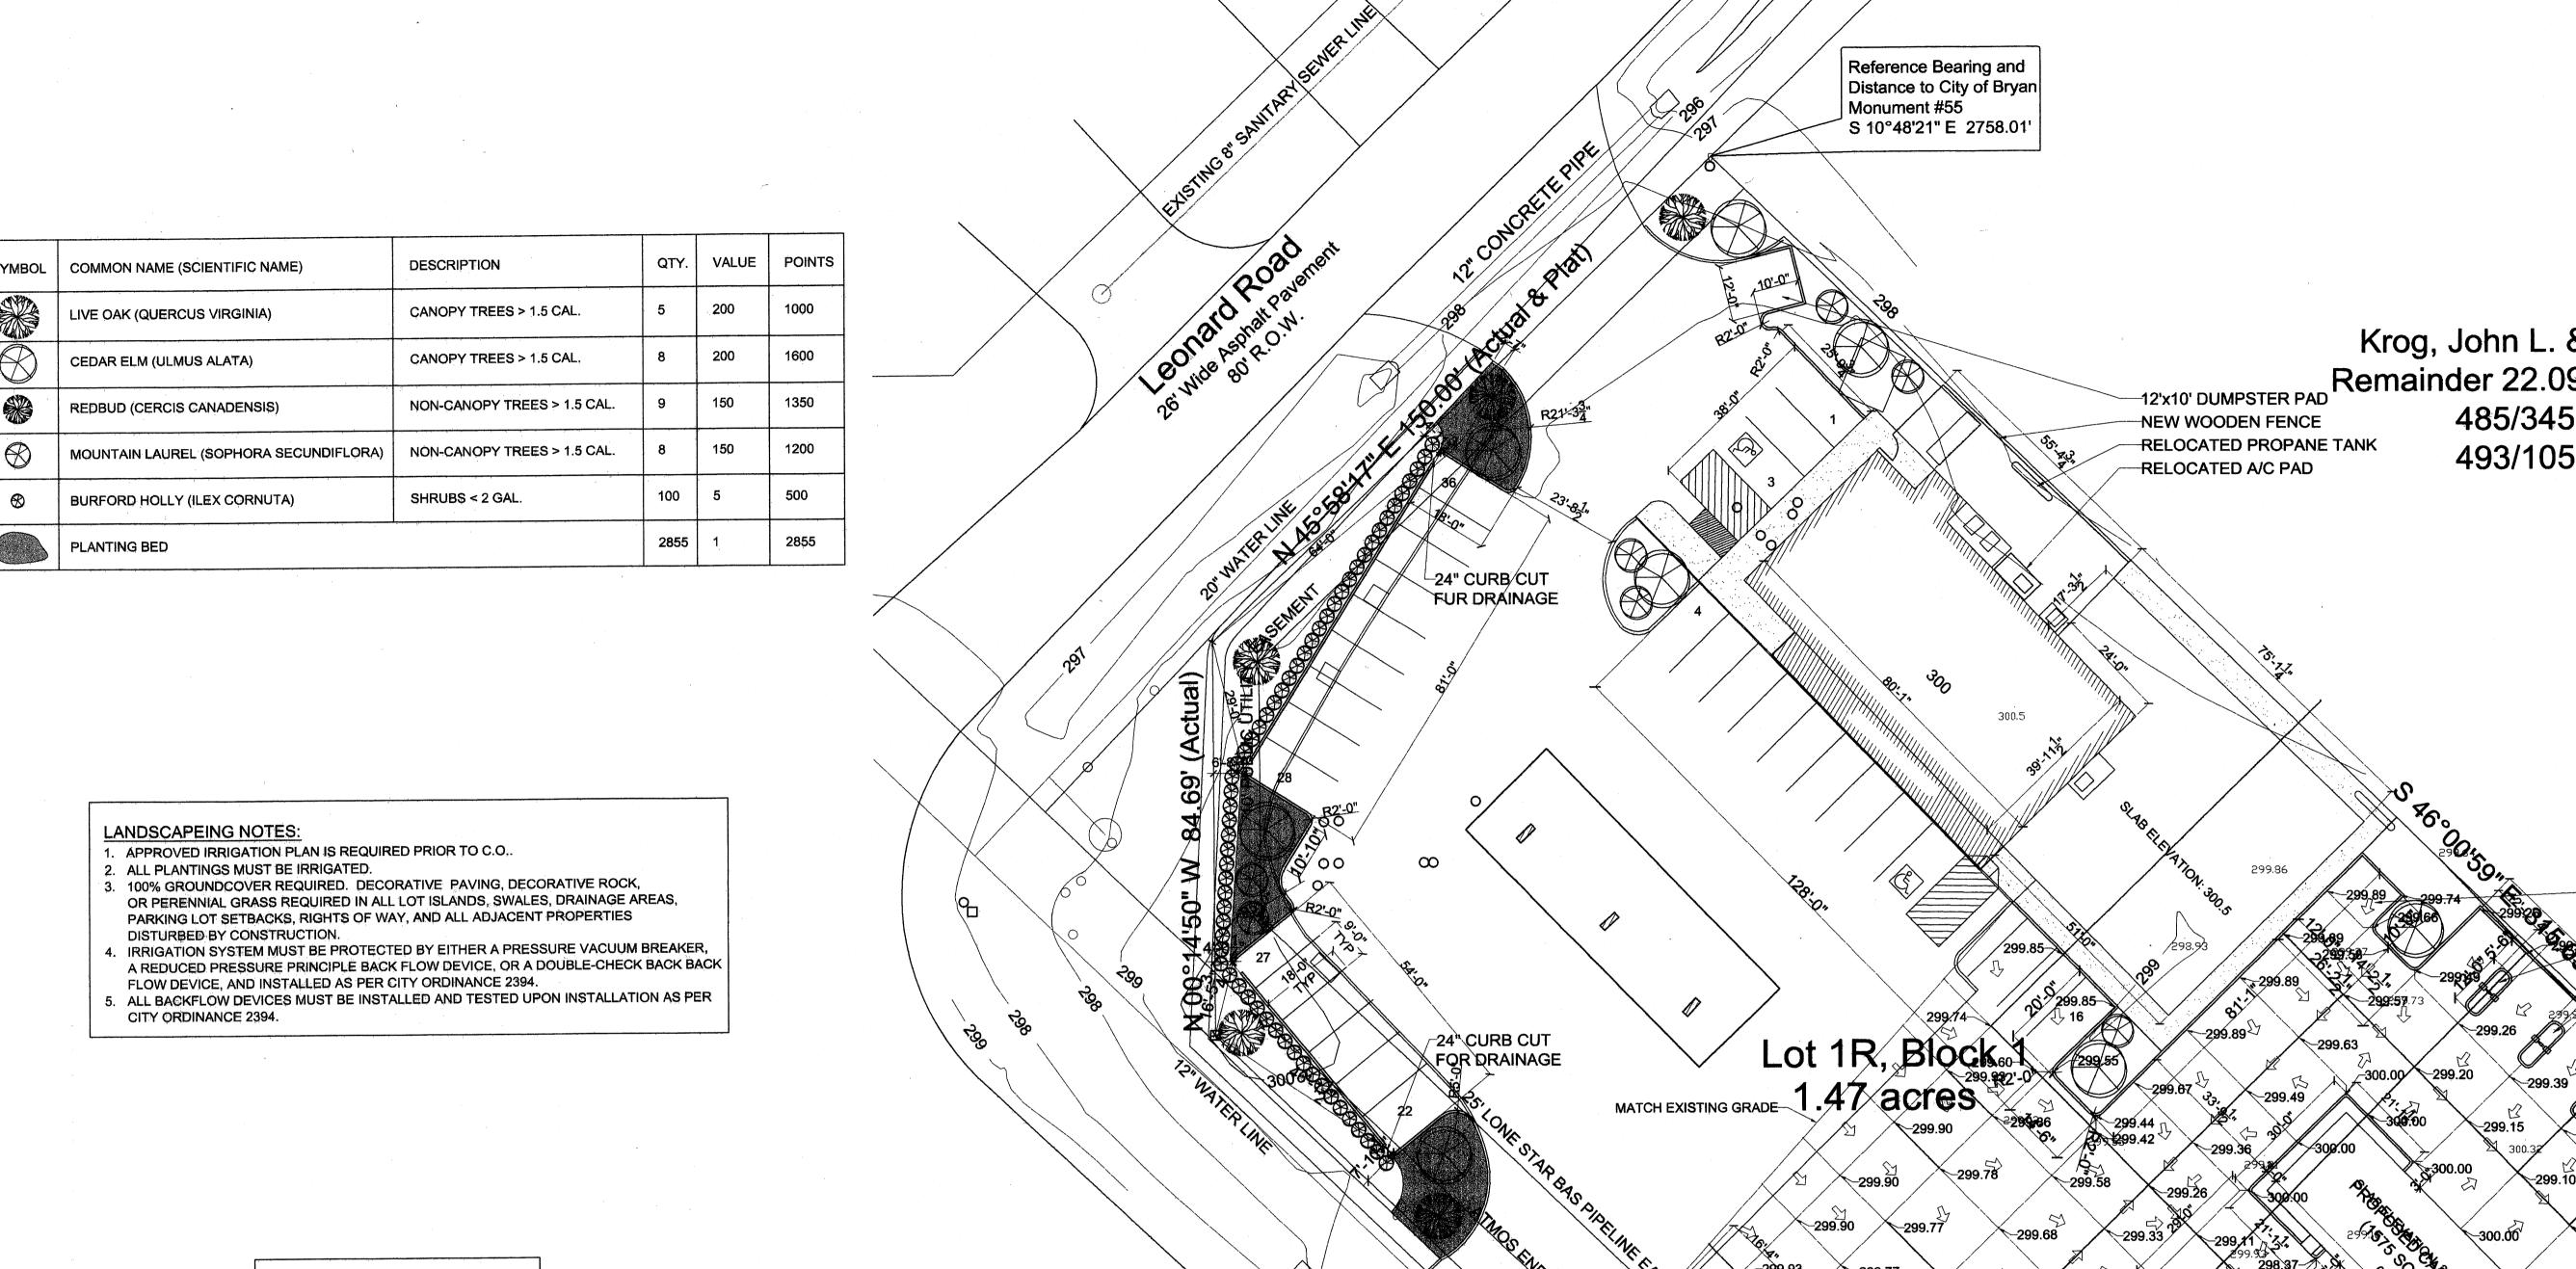


LANDSCAPE ANALYSIS

DEVELOPED AREA: 56,877 SQ. FT. REQUIRED: 15% = 8,531.55


8,531.55 x 50% = 4,266.775 REQUIRED CANOPY TREES: 14 x 200 = 2,800 NON-CANOPY TREES: 13 x 150 = 1,950 TOTAL POINTS FROM TREES: 4,750


SHRUBS: 100 x 5 = 500 PLANTING BEDS: 2855 SQ. FT. = 2855 GRASS: 4,532 SQ. FT. = 453


TOTAL POINTS: 8,558

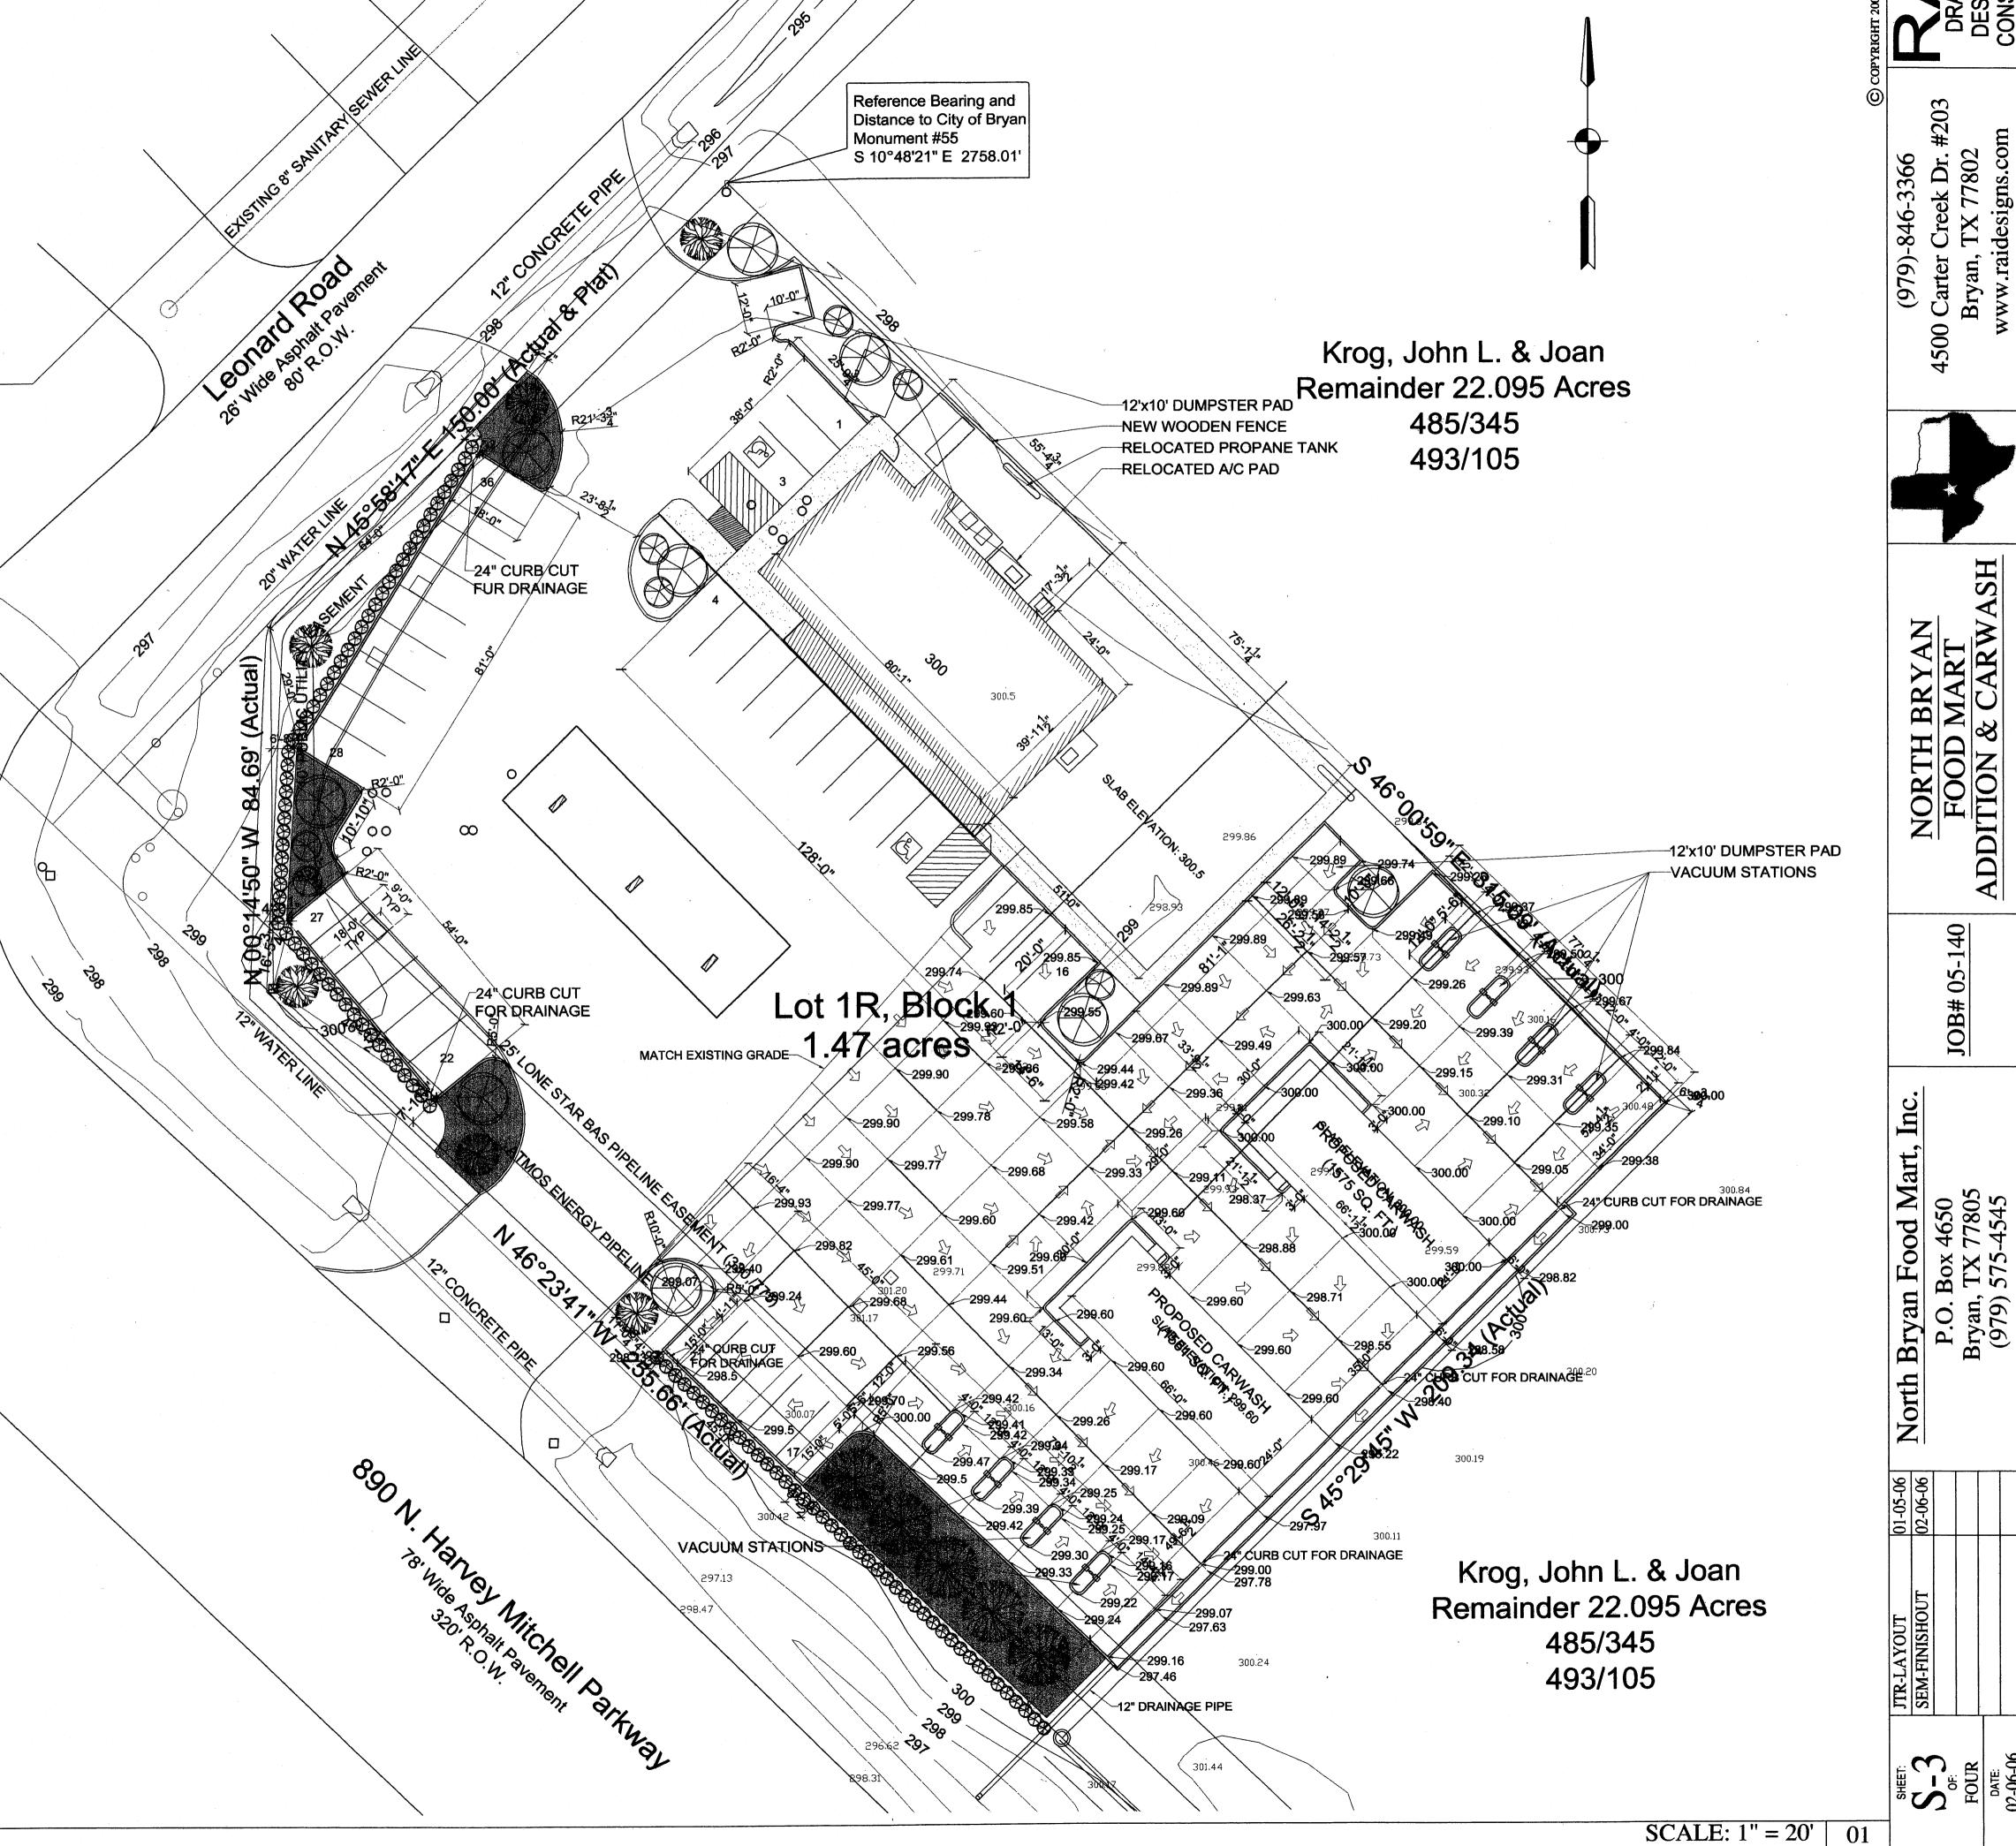

00

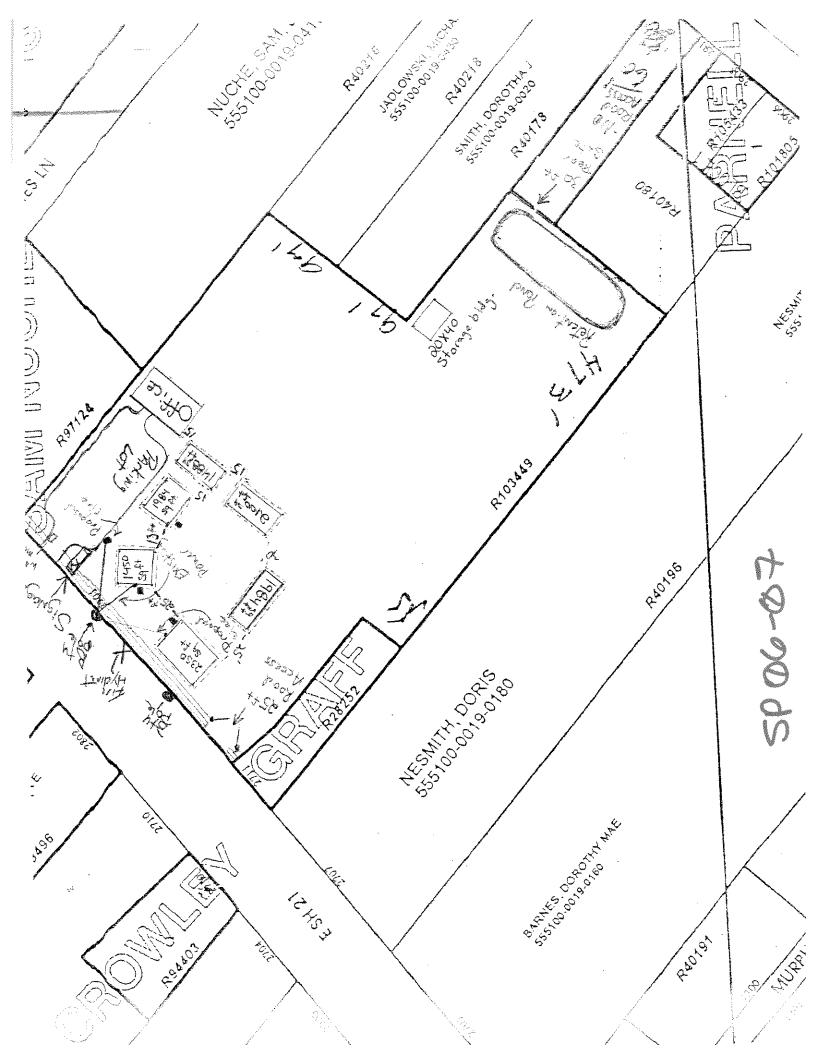


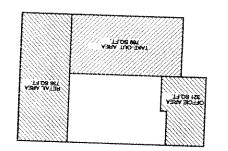


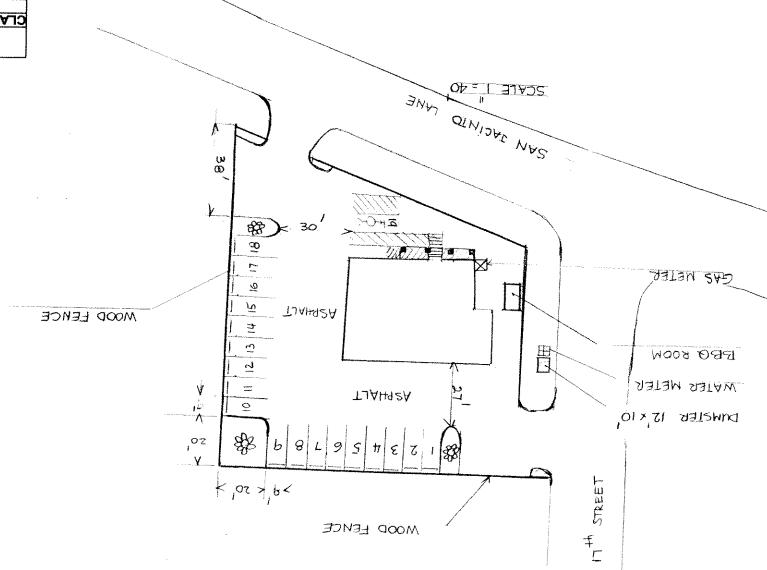


SITE PLAN

81	GEGIVORY JATOT		
56.39			TOTAL REQUIRED
3.02	DIAIDE BA 520 GKO22	.T-1.08 88\.	OFFICE & RETAIL
			JIATAR
86.62	8 + 1 PER 50 SQ.F.T.	TH. Q2 697	ABRA TUO BYAT
			TAKE-OUT
SJATOT		AREA	:LASSIFICATION

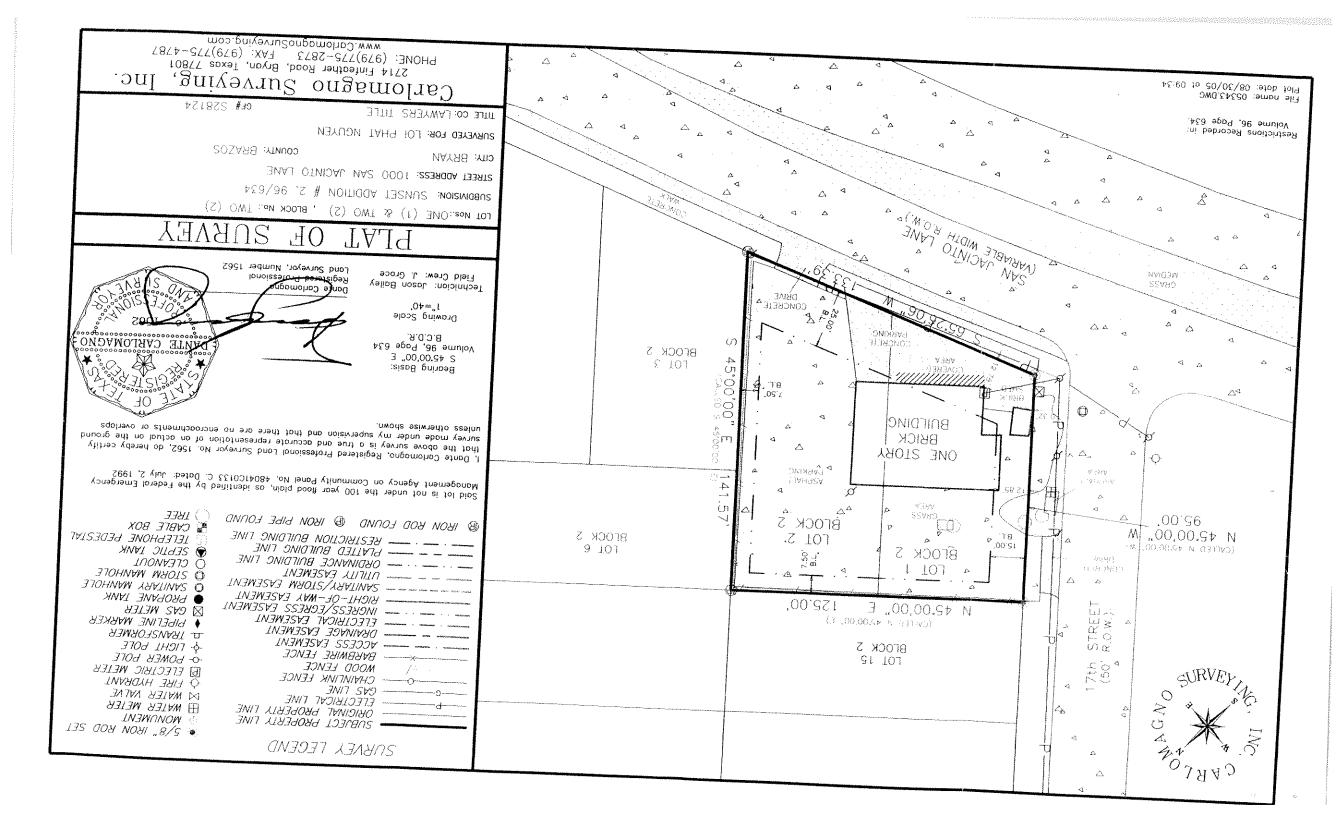

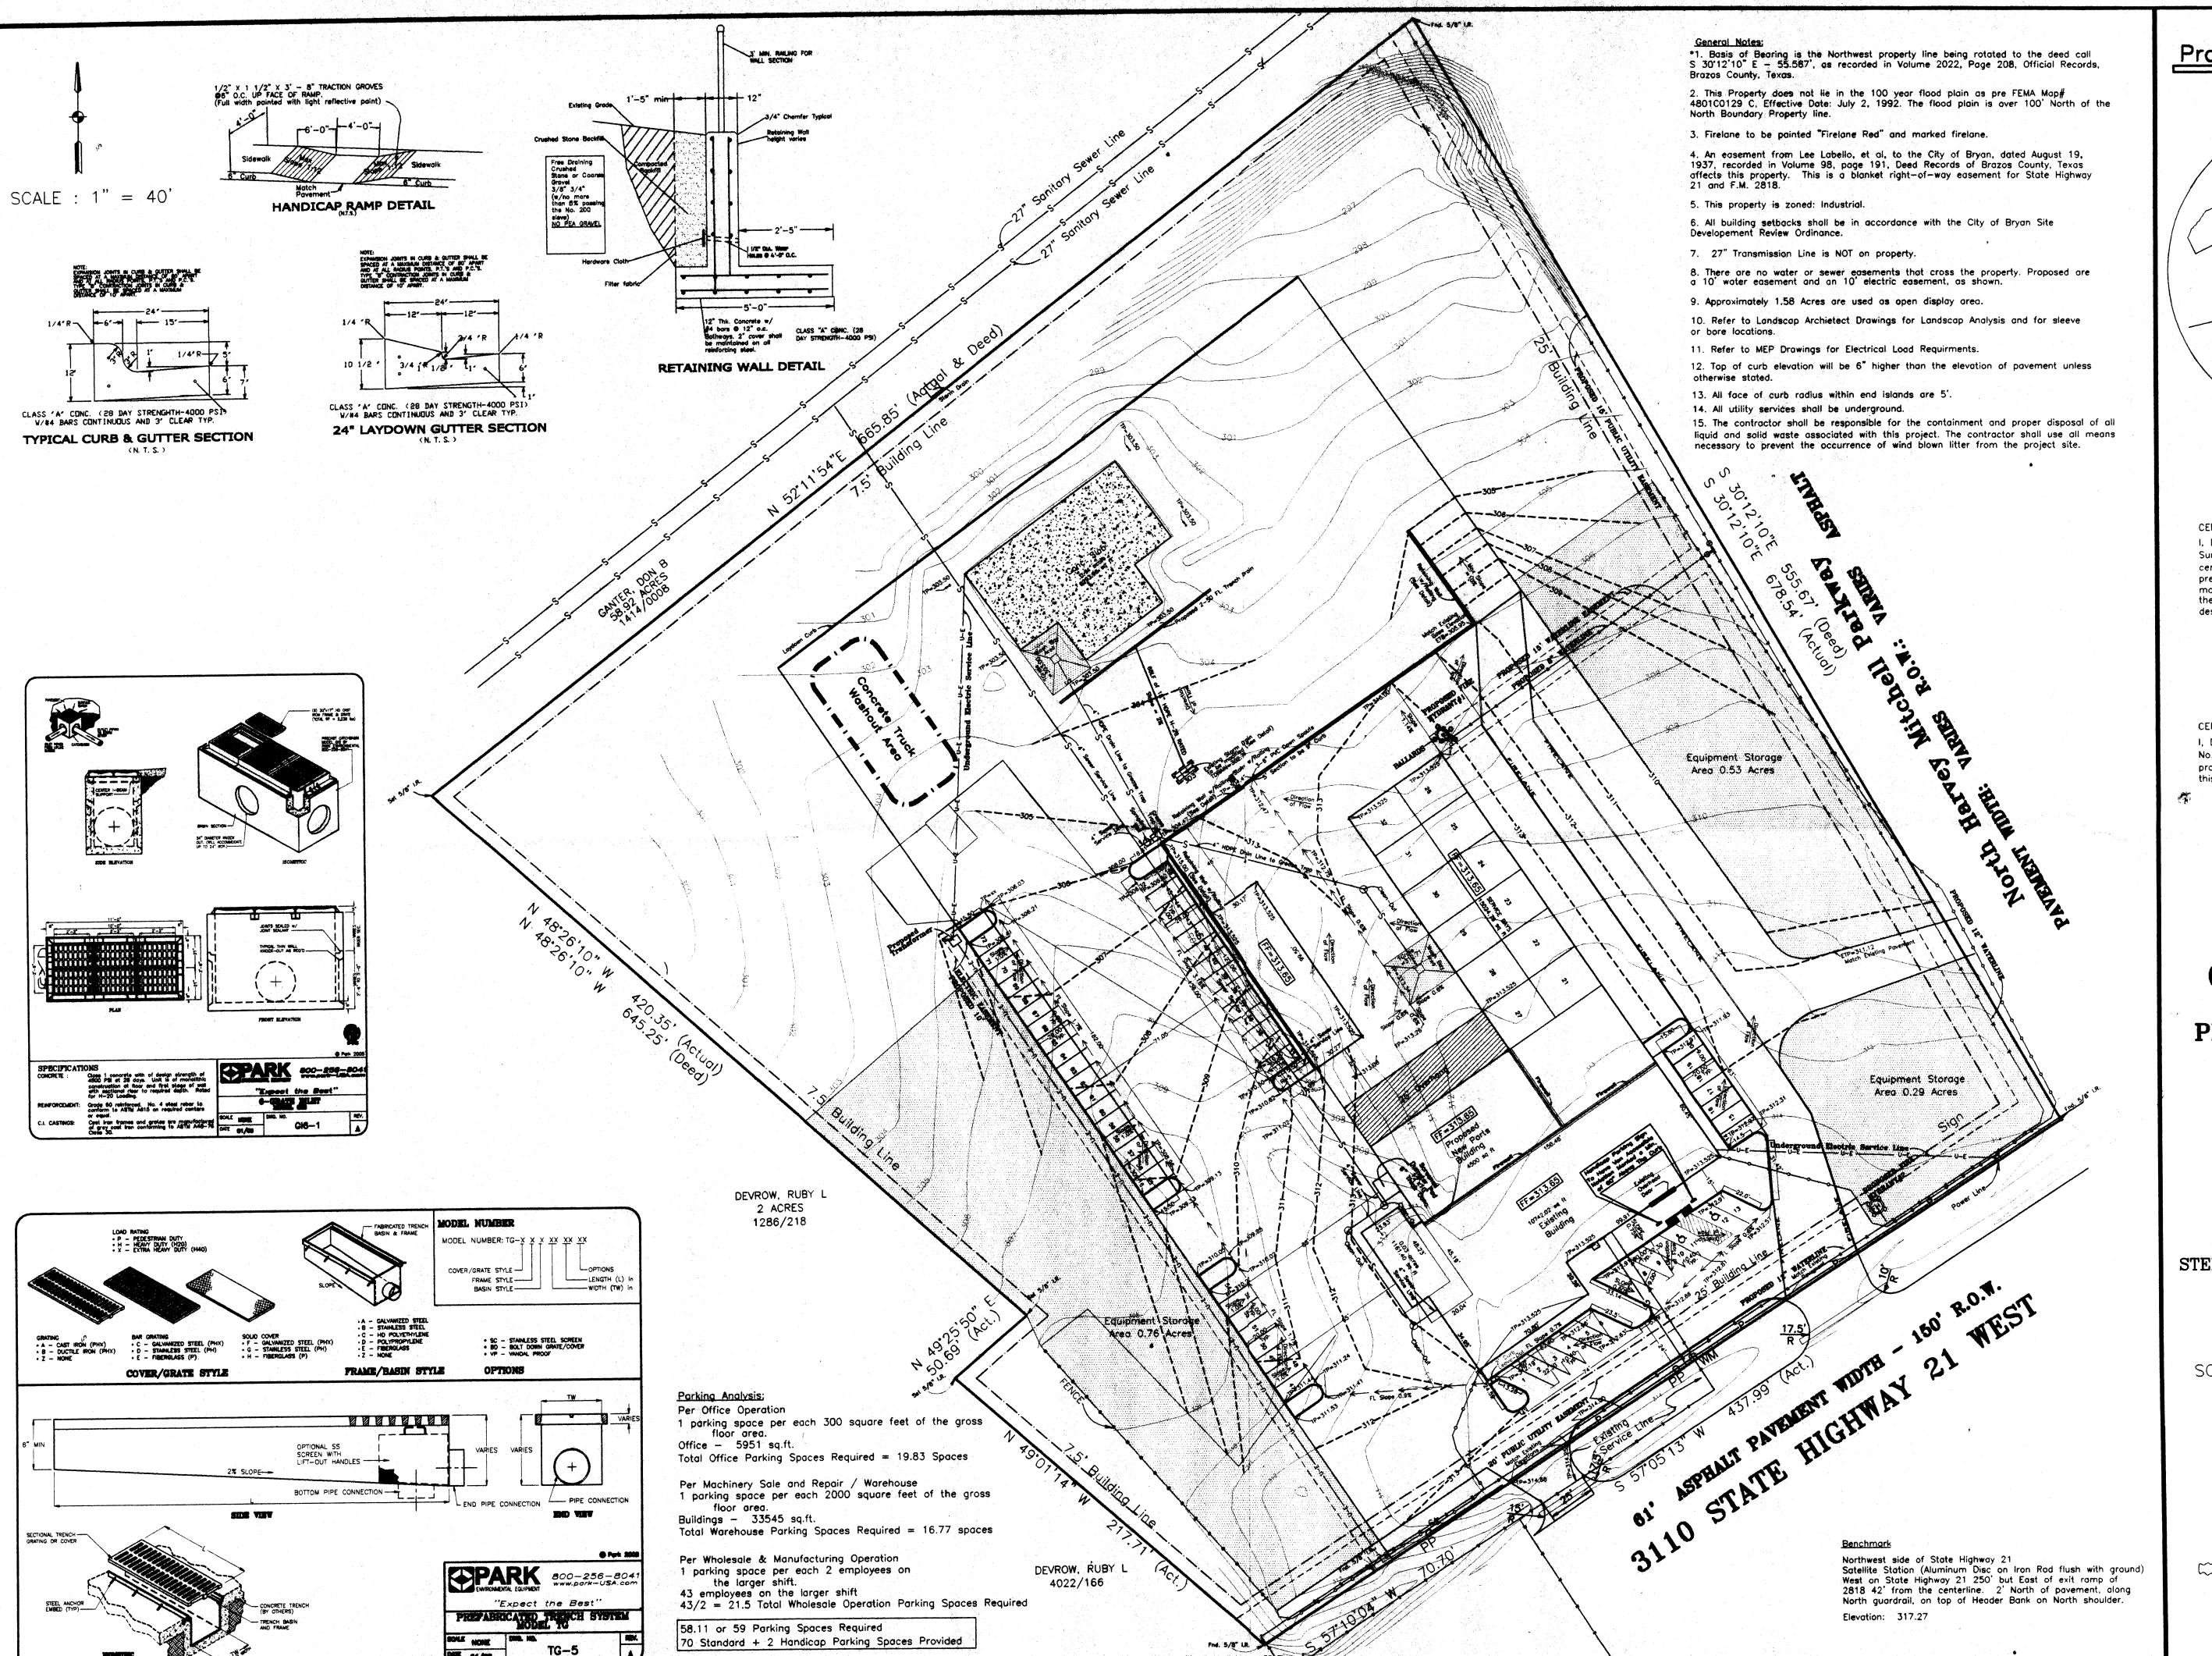

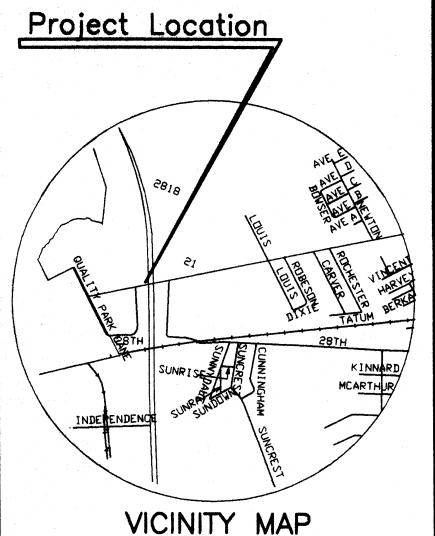

- N.T.S. -

CERTIFICATE OF SURVEYOR

I, Donald D. Garrett, Registered Professional Land Surveyor No.2972, of the State of Texas, hereby certify that this plat is true and correct and was prepared from an actual survey of the property made under my supervision on the ground and that the metes and bounds describe a closed gearner in the state subdivision will describe a closed gearner in the state of the

Dorrand D. Gorrand R.P. S. No. 297

CERTIFICATE OF THE ENGINEER

I, Donald D. Garrett, Registered Professional Engineer No. 22790, in the State of Texas, hereby certify that proper engineering considerables been given to this plat.



SITE and GRADING PLAN of PRATER SUBDIVISION LOT 1 BLOCK 1 8.66 ACRES

Vol. 6131 Pg. 099 0.47 Acres

Vol. 2548 Pg. 313

1.00 Acres

STEPHEN F. AUSTIN, NO.9, A-62
Bryan,
Brazos County, Texas

SCALE : 1"=40' FEB., 2006

OWNER/DEVELOPER:

Coufal-Prater Equipment 3110 Highway 21 West Bryan, TX 77803-1241 (979) 822-7684

GARRETT ENGINEERING

Consulting Engineering & Land Surveying
4444 Carter Creek Parkway Suite 108

Bryan, Texas 77802

Telephone: (979) 846 - 2668

Fax: (979) 846 - 3094

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0

EROSION CONTROL MEASURES SHOWN SHALL BE CONSIDER THE VERY MINIMAL REQUIRED. IT SHALL BE THE RESPONSIBILITY OF THE CONTRACTOR TO IMPLEMENT ALL OTHER EROSION CONTROL MEASURES (DIVERSION BERMS, DRAINAGE STRUCTURES, SWALES, ADDITIONAL FENCING, ETC...) NECESSARY TO KEEP THE EXISTING IMPROVEMENTS AND DEVELOPMENTS FROM DAMAGE OF ANY KIND, DURING ALL PHASES OF DEMOLITION AND CONSTRUCTION.

- 2. THE SITE SUPERINTENDENT, OR HIS REPRESENTATIVE, SHALL MAKE A VISUAL INSPECTION OF ALL SILTATION CONTROLS AND NEWLY STABILIZED AREAS ON A DAILY BASIS; ESPECIALLY AFTER A RAINFALL TO INSURE THAT ALL CONTROLS ARE MAINTAINED AND PROPERLY FUNCTIONING. ANY DAMAGED CONTROLS SHALL BE REPAIRED PRIOR TO THE END OF THE WORK DAY, INCLUDING RE-SEEDING AND MULCHING OR RE-SODDING, IF NECESSARY.
- 3. ALL SEDIMENT TRAPPING DEVICES SHALL BE INSTALLED AS SOON AS PRACTICAL AFTER THE AREA HAS BEEN DISTURBED. ALL SEDIMENT TRAPPING DEVICES SHALL BE CLEANED WHEN THE SEDIMENT LEVEL REACHES 25% CAPACITY. SEDIMENT SHALL BE DISPOSED OF BY SPREADING ON SITE OR HAULING AWAY IF NOT SUITABLE FOR FILL.
- 4. DURING CONSTRUCTION, CONTRACTOR SHALL MAINTAIN BEST MANAGEMENT PRACTICE (BMP). SEDIMENT FENCE, HAY BALE BARRIERS. OR OTHER SEDIMENT TRAPPING DEVICES SHALL CONTROL ALL STORM WATER LEAVING THE SITE.
- THE CONTRACTOR SHALL BE RESPONSIBLE FOR ESTABLISHING TEMPORARY EROSION CONTROL MEASURES AS REQUIRED FOR DIFFERENT PHASES OF CONSTRUCTION. EROSION CONTROL MEASURES SHOWN MAY NEED TO BE ADJUSTED TO HANDLE INCREASED OR CONCENTRATED FLOWS CREATED BY VARIOUS STAGES OF THE CONSTRUCTION.
- THE CONTRACTOR IS RESPONSIBLE FOR FILING A NOTICE OF INTENT PRIOR TO COMMENCEMENT OF WORK AND A NOTICE OF TERMINATION AT THE COMPLETION OF THE PROJECT TO THE TCEQ. A CONSTRUCTION SITE NOTICE, VISIBLE FROM THE PUBLIC RIGHT-OF-WAY SHALL BE POSTED AT THE SITE.
- EROSION CONTROL MEASURES DESIGNATED AS "PHASE TWO" SHALL BE IMPLEMENTED IMMEDIATELY AFTER CONSTRUCTION OF THEIR ASSOCIATED IMPROVEMENTS.
- 8. THE CONTRACTOR IS RESPONSIBLE FOR REMOVING SEDIMENT CONTROL DEVICES AFTER THE SITE HAS BEEN SEEDED AND/OR SODDED, AND GROUND COVER HAS TAKEN ROOT.
- 9. THE CONTRACTOR SHALL TAKE ALL NECESSARY MEASURES TO ENSURE THAT ALL DISTURBED AREAS ARE STABILIZED. DESIGNATED AREAS SHALL BE BLOCK SODDED, AND ALL OTHER AREAS DISTURBED DUE TO CONSTRUCTION SHALL BE HYDRO-MULCHED SEEDED. THESE STABILIZED AREAS SHALL BE SODDED OR SEEDED, FERTILIZED, AND WATERED TO ESTABLISH A SOLID GROUND COVER WITHIN 30 DAYS OF COMPLETION, OR IF ACTIVITY CEASES FOR MORE THAN 14 DAYS.
- 10. WHEN HYDROMULCH IS REQUIRED, CONTRACTOR SHALL KEEP MULCH MOIST AFTER INSTALLATION AND UNTIL AREA SHOWS GROWTH.
- 11. CONTRACTOR SHALL SOD RIGHT-OF-WAY AFTER DRIVES, GRADING, AND SIDEWALKS HAVE BEEN CONSTRUCTED.
- 12. THE TXDOT STANDARD DETAIL SHEET EC(2)-93 IS ISSUED AS A A PART OF THE CIVIL CONSTRUCTION DRAWINGS.
- 13. SEE CIVIL DETAIL SHEET C2.2 FOR MISCELLANEOUS EROSION CONTROL DETAILS.

#### GENERAL CONSTRUCTION NOTES:

THE CONTRACTOR SHALL PROMPTLY NOTIFY THE ENGINEER OF ANY DISCREPANCIES BETWEEN THESE PLANS AND OTHER CONSTRUCTION DRAWINGS OF DIFFERING DISCIPLINES & SPECIFICATIONS.

2. THE CONTRACTOR IS SPECIFICALLY CAUTIONED THAT THE LOCATION AND/OR ELEVATION OF THE EXISTING UTILITIES AS SHOWN ON THESE CONSTRUCTION PLANS IS BASED ON RECORDS OF THE VARIOUS UTILITY COMPANIES AND, WHERE POSSIBLE MEASUREMENTS TAKEN IN THE FIELD. THE INFORMATION IS NOT TO BE RELIED UPON AS BEING EXACT OR COMPLETE. IT IS THE CONTRACTOR'S RESPONSIBILITY TO AVOID ALL EXISTING UTILITIES AND REPAIR ANY DAMAGED LINES, AT HIS OWN EXPENSE, WHETHER THE UTILITY IS SHOWN ON THE PLANS OR NOT. THE CONTRACTOR SHALL NOTIFY THE APPROPRIATE UTILITY COMPANY 48 HOURS PRIOR TO ANY EXCAVATION. THE CONTRACTOR SHALL ALSO NOTIFY THE ENGINEER IF DESIGN CHANGES NEED TO BE MADE IN THE FIELD.

**CONTACT INFORMATION:** TEXAS ONE CALL: 800-245-4545 LONE STAR ONE CALL: (800) 669-8344 TEXAS EXCAVATION SAFETY SYSTEM (DIGTESS): (800) 344-8377 BRYAN TEXAS UTILITIES (BTU): ELECTRICAL DIVISION - (979) 821-5865 CoB: ENGINEERING DIVISION - (979) 209-5030 CoB: WATER SERVICES DIVISION - (979) 209-5900 CoB: SANITATION DIVISION - (979) 209-5934 VERIZON: JIM SURVANT - (979) 821-4300

ATMOS ENERGY: KIMBERLY WINN - (979) 774-2506

EXXON-MOBILE: MICHAEL HLUZA - (281) 591-3720

COX COMMUNICATIONS: MIKE LAVENDER - (979) 846-2229

3. CONTRACTOR TO VERIFY ALL UNDERGROUND UTILITIES IN THE FIELD PRIOR TO CONSTRUCTION.

4. THE CONTRACTOR SHALL BE RESPONSIBLE FOR THE PROTECTION OF ALL EXISTING UTILITIES OR SERVICE LINES THAT ARE CROSSED OR EXPOSED DURING CONSTRUCTION OPERATIONS. WHERE EXISTING UTILITIES OR SERVICE LINES ARE CUT, BROKEN, OR DAMAGED, THE CONTRACTOR SHALL REPAIR OR REPLACE THE UTILITIES OR SERVICE LINE WITH THE SAME TYPE OF MATERIAL AND CONSTRUCTION OR BETTER; THIS MATERIAL AND WORK SHALL BE AT THE CONTRACTOR'S OWN EXPENSE.

DURING THE EXECUTION OF THE WORK, THE CONTRACTOR SHALL MAINTAIN THE PROJECT SITE IN AN ORDERLY AND ACCEPTABLE MANNER AS FAR AS PRACTICAL. THE CONTRACTOR SHALL CLEAN AND REMOVE FROM THE PROJECT AREA ALL SURPLUS AND DISCARDED MATERIALS, TEMPORARY STRUCTURES, AND DEBRIS OF ANY KIND AND SHALL LEAVE THE PROJECT SITE IN A NEAT AND ORDERLY CONDITION. ALL CLEAN UP WILL BE DONE TO THE SATISFACTION OF THE ENGINEER.

6. THE EXISTING SITE & EROSION CONTROL PLAN, PREPARED BY RME IS NOT TO BE CONSIDERED A DEMOLITION PLAN. THE CONTRACTOR SHALL COORDINATE THIS WORK AND PROCEDURES WITH PREMIER BUILDERS, INC.

7. CONTRACTOR SHALL COMPLY WITH LATEST EDITION OF OSHA REGULATIONS AND THE STATE OF TEXAS LAWS CONCERNING EXCAVATION.

#### GENERAL CONSTRUCTION NOTES (CONT'D):

8. CONTRACTOR SHALL MAINTAIN A SET OF REDLINE DRAWINGS RECORDING AS-BUILT CONDITIONS DURING CONSTRUCTION. THESE REDLINE MARKED UP DRAWINGS WILL BE SUBMITTED TO THE DESIGN CONSULTANT WHO WILL MAKE THE CHANGES ON THE ORIGINAL TRACINGS, LABELING EACH SHEET IN THE SET AS "RECORD DRAWINGS", AND RETURNING SAME TO THE CITY ENGINEER.

9. THE CONTRACTOR SHALL BE RESPONSIBLE FOR SAFEGUARDING AND PROTECTING ALL MATERIAL AND EQUIPMENT STORED ON THE JOBSITE. THE CONTRACTOR SHALL BE RESPONSIBLE FOR THE STORAGE OF MATERIALS IN A SAFE AND WORKMANLIKE MANNER TO PREVENT INJURIES, DURING AND AFTER WORKING HOURS, UNTIL PROJECT COMPLETION.

10. CONTRACTOR SHALL SAW CUT REMOVE AND REPLACE CONCRETE PAVEMENT, CURB AND GUTTER AS REQUIRED TO CONSTRUCT PROPOSED DRIVEWAY.

11. PREMIER BUILDERS, INC. (GENERAL CONTRACTOR) SHALL BE RESPONSIBLE FOR COORDINATING EROSION CONTROL BETWEEN PHASE ONE DEVELOPMENT AND THE EXISTING PETE'S EXXON IMPROVEMENTS. THE PHASE LINE SHOWN IS APPROXIMATE AND ITS EXACT LOCATION SHALL BE DETERMINED BY THE GENERAL CONTRACTOR.

11. IT SHALL BE THE RESPONSIBILITY OF THE CONTRACTOR TO PAY FOR AND OBTAIN ALL REQUIRED PERMITS AND NSPECTION APPROVALS FOR ALL WORK SHOWN.

12. ANY ADJACENT PROPERTY AND RIGHT-OF-WAY DISTURBED DURING CONSTRUCTION WILL BE RETURNED TO THEIR EXISTING CONDITIONS OR BETTER.



DRAINAGE AREA LABEL (REPORTS THE 100-YEAR RAINFALL EVENT)

EROSION CONTROL LEGEND

FILTER FABRIC FENCE REINFORCED FILTER X — RFB FABRIC FENCE

STABILIZED CONSTRUCTION ENTRANCE INLET PROTECTION

**PROJECT BENCHMARK:** 

"X" CHISELED IN NORTH CORNER OF CURB INLET LOCATED ON VILLIA MARIA NEAR THE NORTHWEST CORNER OF PETE'S EXXON PROPERTY. CONTACT GARRETT ENGINEERING & LAND SURVEYING FOR ELEVATION DATUM INFORMATION.

SUBSTANTIALLY CONSTRUCTION 2/8/06

**K** ABON

CNGINEERING

POST OFFICE BOX 9253

OFFICE - (979) 690-0329

FAX - (979) 690-0329

CELL - (979) 219-4174

SARRETT ENGINEERING

DFF: (979) 846—2688

FAX: (979) 846-3094


3RYAN, TX 77802

4444 CARTER CREEK PKWY

COLLEGE STATION, TEXAS 77842

EMAIL: rmengineer@verizon.net

CONSTRUCTION DRAWINGS ISSUED PRIOR TO THIS DATE ARE REPLACED BY THIS SET & SHOULD NOT BE USED FOR CONSTRUCTION.

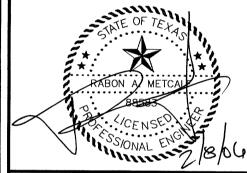


CLIENT INFORMATION PREMIER BUILDERS, INC. c/o CHARLES TAYLOR, III 2402 BROADMOOR, BLDG. D, STE. 101 BRYAN, TX 77802 | OFF: (979) 776-2212 FAX: (979) 776-2214

FILENAME: 0269EC1A SCALE: 1" = 20'CONTRACT DATE: NOV. 11, 2005 RAWN BY: R.A.M.

HECKED BY: R.A.M. ELD BOOK: N/A PAGES: N/A

RABON METCALF ENGINEERING CLIENT NO. PROJECT NO 153 - 0269

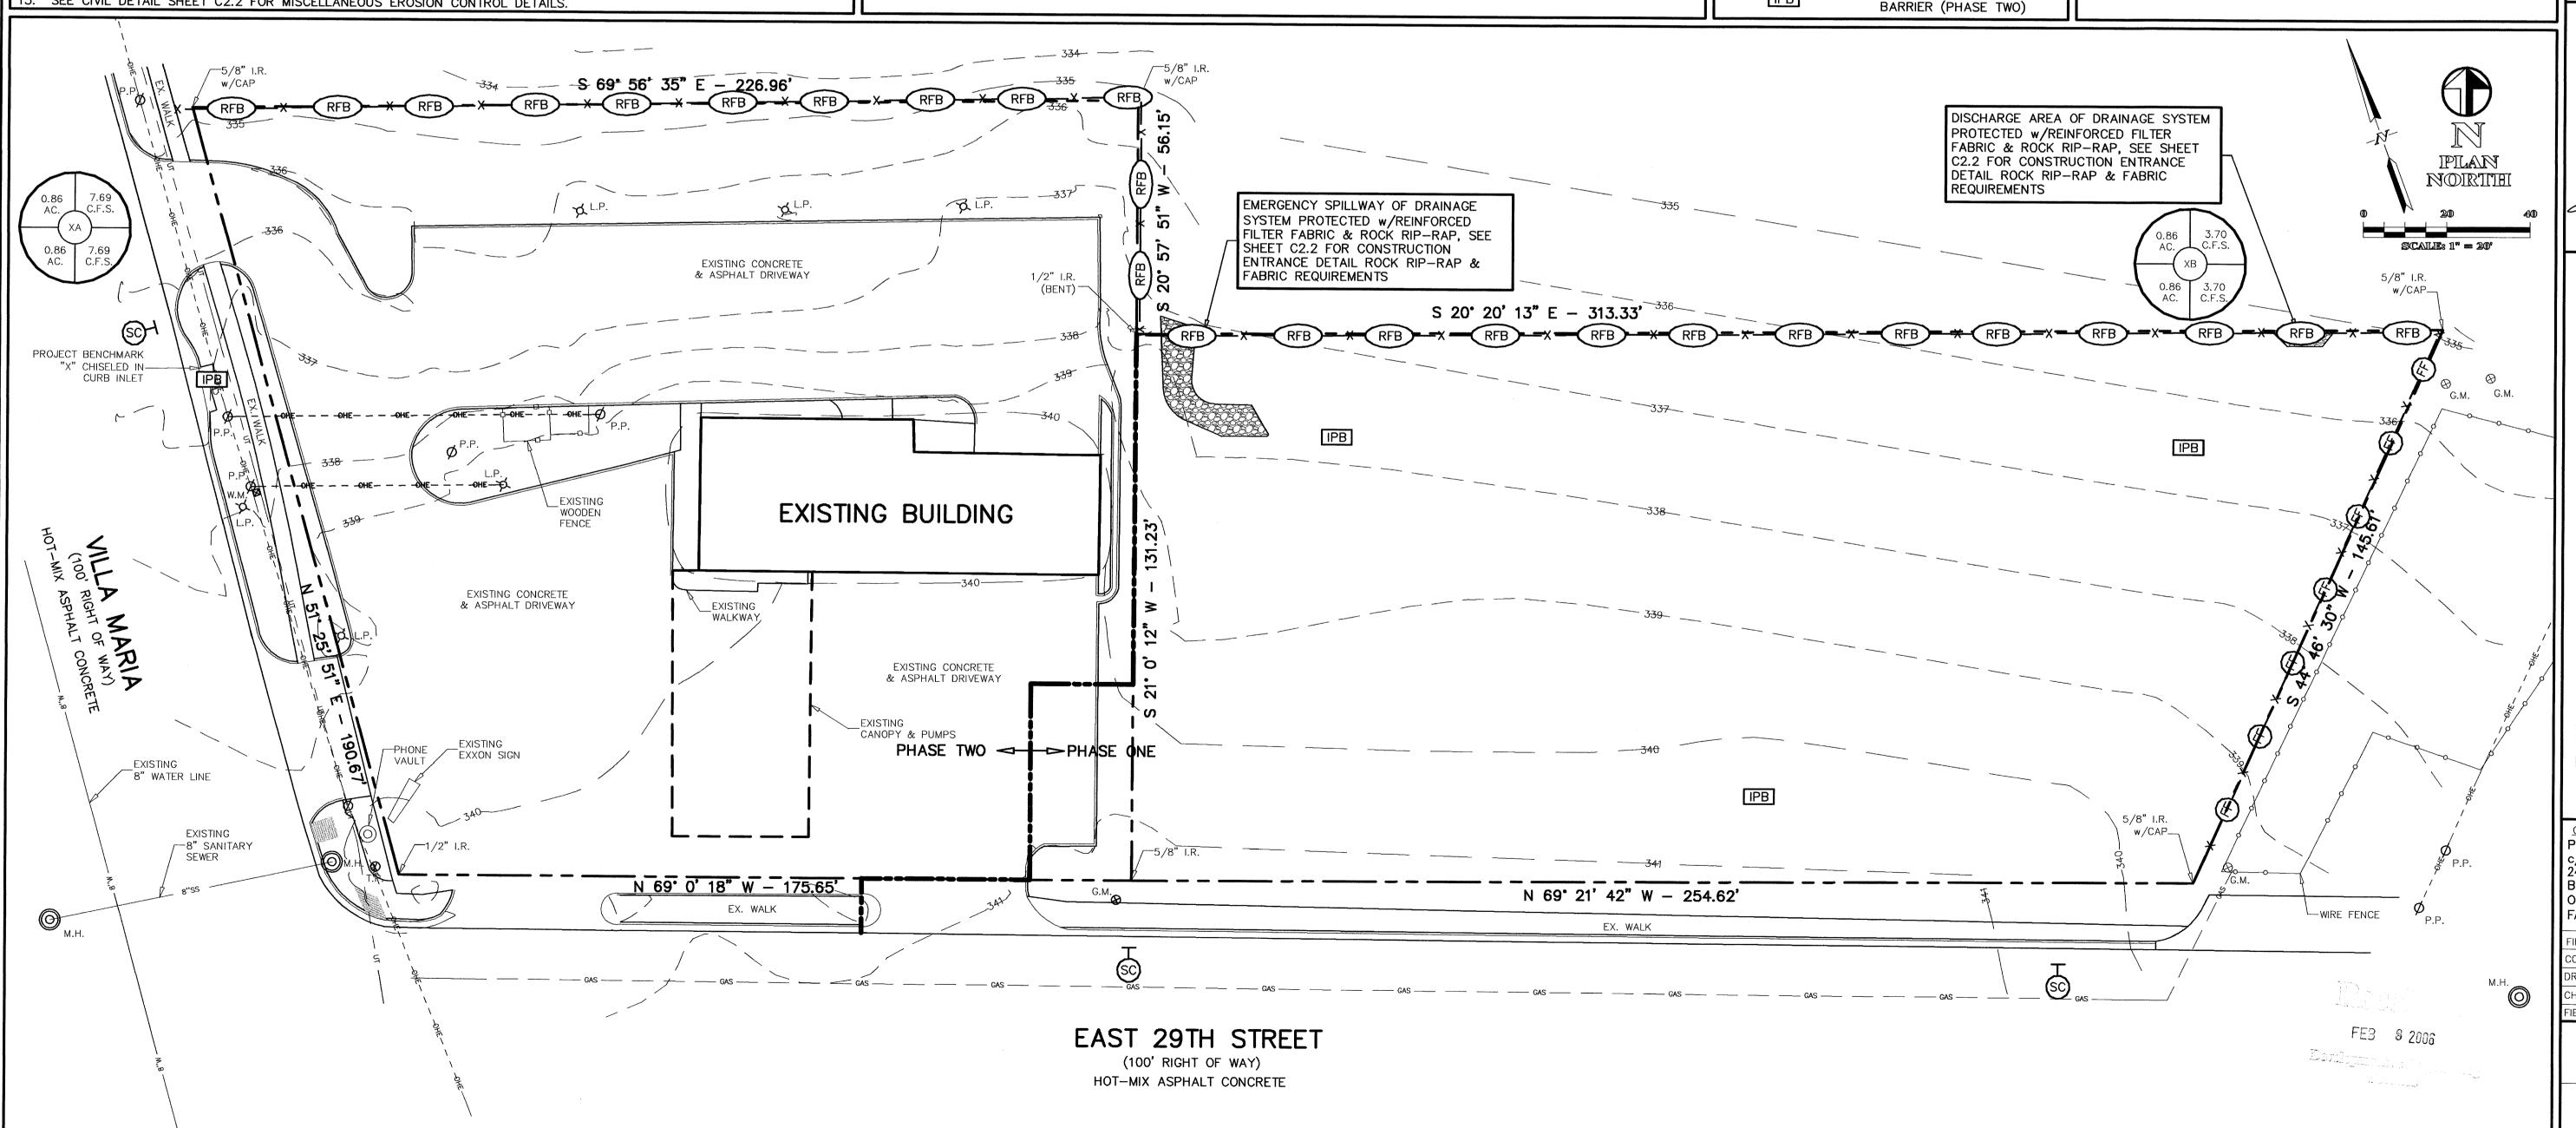

### **GRADING NOTES:**

- . ALL UNPAVED AREAS SHALL BE ADEQUATELY GRADED TO DRAIN AT A MINIMUM OF 1.00% SLOPE SO THAT NO PONDING OCCURS.
- 2. UNLESS OTHERWISE SPECIFIED UNPAVED AREAS SHALL DRAIN AWAY FROM BUILDINGS AT A MINIMUM SLOPE OF 1.00% OR SO THAT THE PERIMETER CURB IS 6" LOWER THAN THE FINISH FLOOR.
- 3. FINISH GRADE ADJACENT TO CURBING OR SIDEWALKS SHALL BE 2" BELOW THE TOP OF CONCRETE AND IN LANDSCAPING AREAS, 2" BELOW.
- 4. WHEN GRADES FOR TOP OF CURB AND GUTTER FLOWLINE DIFFER, THE SLOPES SHOWN ARE FOR THE GUTTER FLOWLINE.
- 5. WHEN TOP OF CURB ELEVATIONS ARE SHOWN, THE CURB HEIGHT IS 6" UNLESS OTHERWISE SPECIFIED.
- 6. THE CONTRACTOR SHALL INSURE THAT ALL ENTRANCES AND ACCESSIBLE PATHS, TO AND FROM THE BUILDING, TO DESIGNATED H/C PARKING SPACES MEET ALL TEXAS ACCESSIBILITY CODES AND ADA STANDARDS.
- 7. THE CONTRACTOR SHALL FOLLOW THE GENERAL INTENT OF THE GRADING PLANS. MINOR ADJUSTMENTS TO ACTUAL ELEVATIONS SHOWN ON THE GRADING PLAN MAY BE REQUIRED TO MATCH EXISTING GROUND ELEVATIONS & STRUCTURES.
- 8. SLOPES BETWEEN PROPOSED CONTOURS SHALL BE 4:1 (MAXIMUM) UNLESS OTHERWISE SPECIFIED (DO NOT SCALED).
- 9. ADEQUATE DRAINAGE SHALL BE MAINTAINED AT ALL TIMES DURING CONSTRUCTION AND ANY DRAINAGE DITCH OR STRUCTURE DISTURBED DURING CONSTRUCTION SHALL BE RESTORED TO EXISTING CONDITIONS OR BETTER.
- 10. THIS PLAN IS FOR "GRADING ONLY". THE CONTRACTOR SHALL REFER TO PREMIER BUILDER'S, INC. DRAWINGS FOR ALL PAVING AND STRUCTURAL DETAILS (CURB & GUTTER, SIDEWALKS, STEPS, HANDRAILS, RETAINING WALLS, ETC...).
- 11. SEE CIVIL DETAIL SHEET C2.1 FOR MISCELLANEOUS GRADING DETAILS.

#### SITE NOTES:

THIS ENTIRE SITE DOES NOT LIE WITHIN THE 100-YEAR FLOODPLAIN AS GRAPHICALLY DEPICTED BY F.E.M.A. FIRM COMMUNITY PANEL NO. 48041 0133C, WITH AN EFFECTIVE DATE OF JULY 2, 1992.

PERFORMANCE, ACCURACY, FREEDOM FROM ERROR, OR AS TO ANY RESULTS GENERATED THROUGH ITS USE. THE RECIPIENT ALSO UNDERSTAND AND AGREES THAT RME, UPON RELEASE OF SUCH DATA, IS NO LONGER RESPONSIBLE FOR THEIR USE OR MODIFICATION. THE USER AND RECIPIENT OF THE ELECTRONIC DATA ACCEPTS FULL RESPONSIBILITY AND LIABILITY FOR ANY CONSEQUENCES ARISING OUT OF THEIR USE.

**PROJECT BENCHMARK:** 

"X" CHISELED IN NORTH CORNER OF CURB INLET

LOCATED ON VILLIA MARIA NEAR THE NORTHWEST CORNER OF PETE'S EXXON PROPERTY. CONTACT

GARRETT ENGINEERING & LAND SURVEYING FOR

GRADING AND PAVEMENT TRANSITIONS BETWEEN PHASE ONE DEVELOPMENT AND THE EXISTING PETE'S EXXON IMPROVEMENTS. THE PHASE LINE SHOWN IS APPROXIMATE AND ITS EXACT LOCATION SHALL BE

## SUBSTANTIALLY **COMPLETE FOR** CONSTRUCTION

**K** ABON

POST OFFICE BOX 9253

OFFICE - (979) 690-0329

CELL - (979) 219-4174

BRYAN, TX 77802

OFF: (979) 846-2688

FAX: (979) 846-3094

**COLLEGE STATION, TEXAS 77842** 

2/8/06 CONSTRUCTION DRAWINGS ISSUED PRIOR TO THIS DATE ARE REPLACED BY THIS SET & SHOULD NOT BE USED FOR

CONSTRUCTION.

EXXON TH STREET AS 77803 TE'S \ST 29 ' TEX/ PE, AN, 2


CLIENT INFORMATION PREMIER BUILDERS, INC. c/o CHARLES TAYLOR, III 2402 BROADMOOR, BLDG. D. STE. 101 BRYAN, TX 77802 OFF: (979) 776-2212 FAX: (979) 776-2214

FILENAME: 0269GP1A SCALE: 1" = 20'CONTRACT DATE: NOV. 11, 2005 DRAWN BY: R.A.M.

CHECKED BY: R.A.M. IELD BOOK: N/A PAGES: N/A


RABON METCALF ENGINEERING CLIENT NO. PROJECT NO 153 - 0269


SHEET NO.

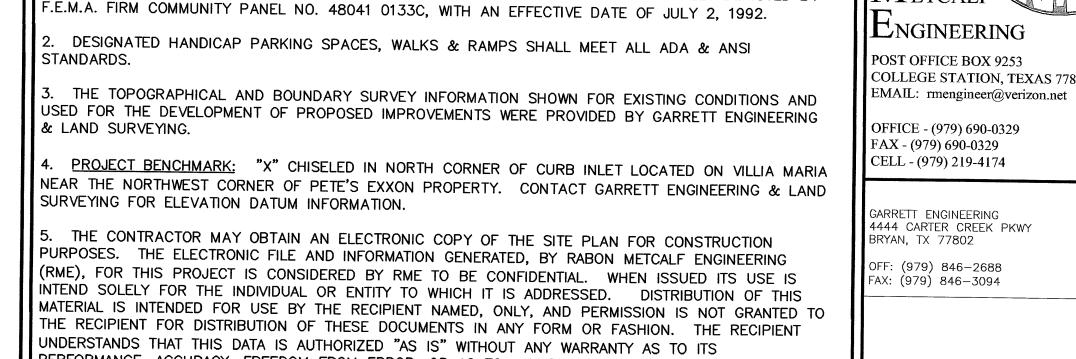

6. PREMIER BUILDERS, INC. (GENERAL CONTRACTOR) SHALL BE RESPONSIBLE FOR COORDINATING DETERMINED BY THE GENERAL CONTRACTOR.

GRADING LEGEND DRAINAGE DIRECTIONAL ARROW TOP OF PAVEMENT T/P=100.00 T/C=100.00 TOP OF CURB OR CONCRETE T/W=100.00 TOP OF WALL TOP OF GROUND OR GRATE

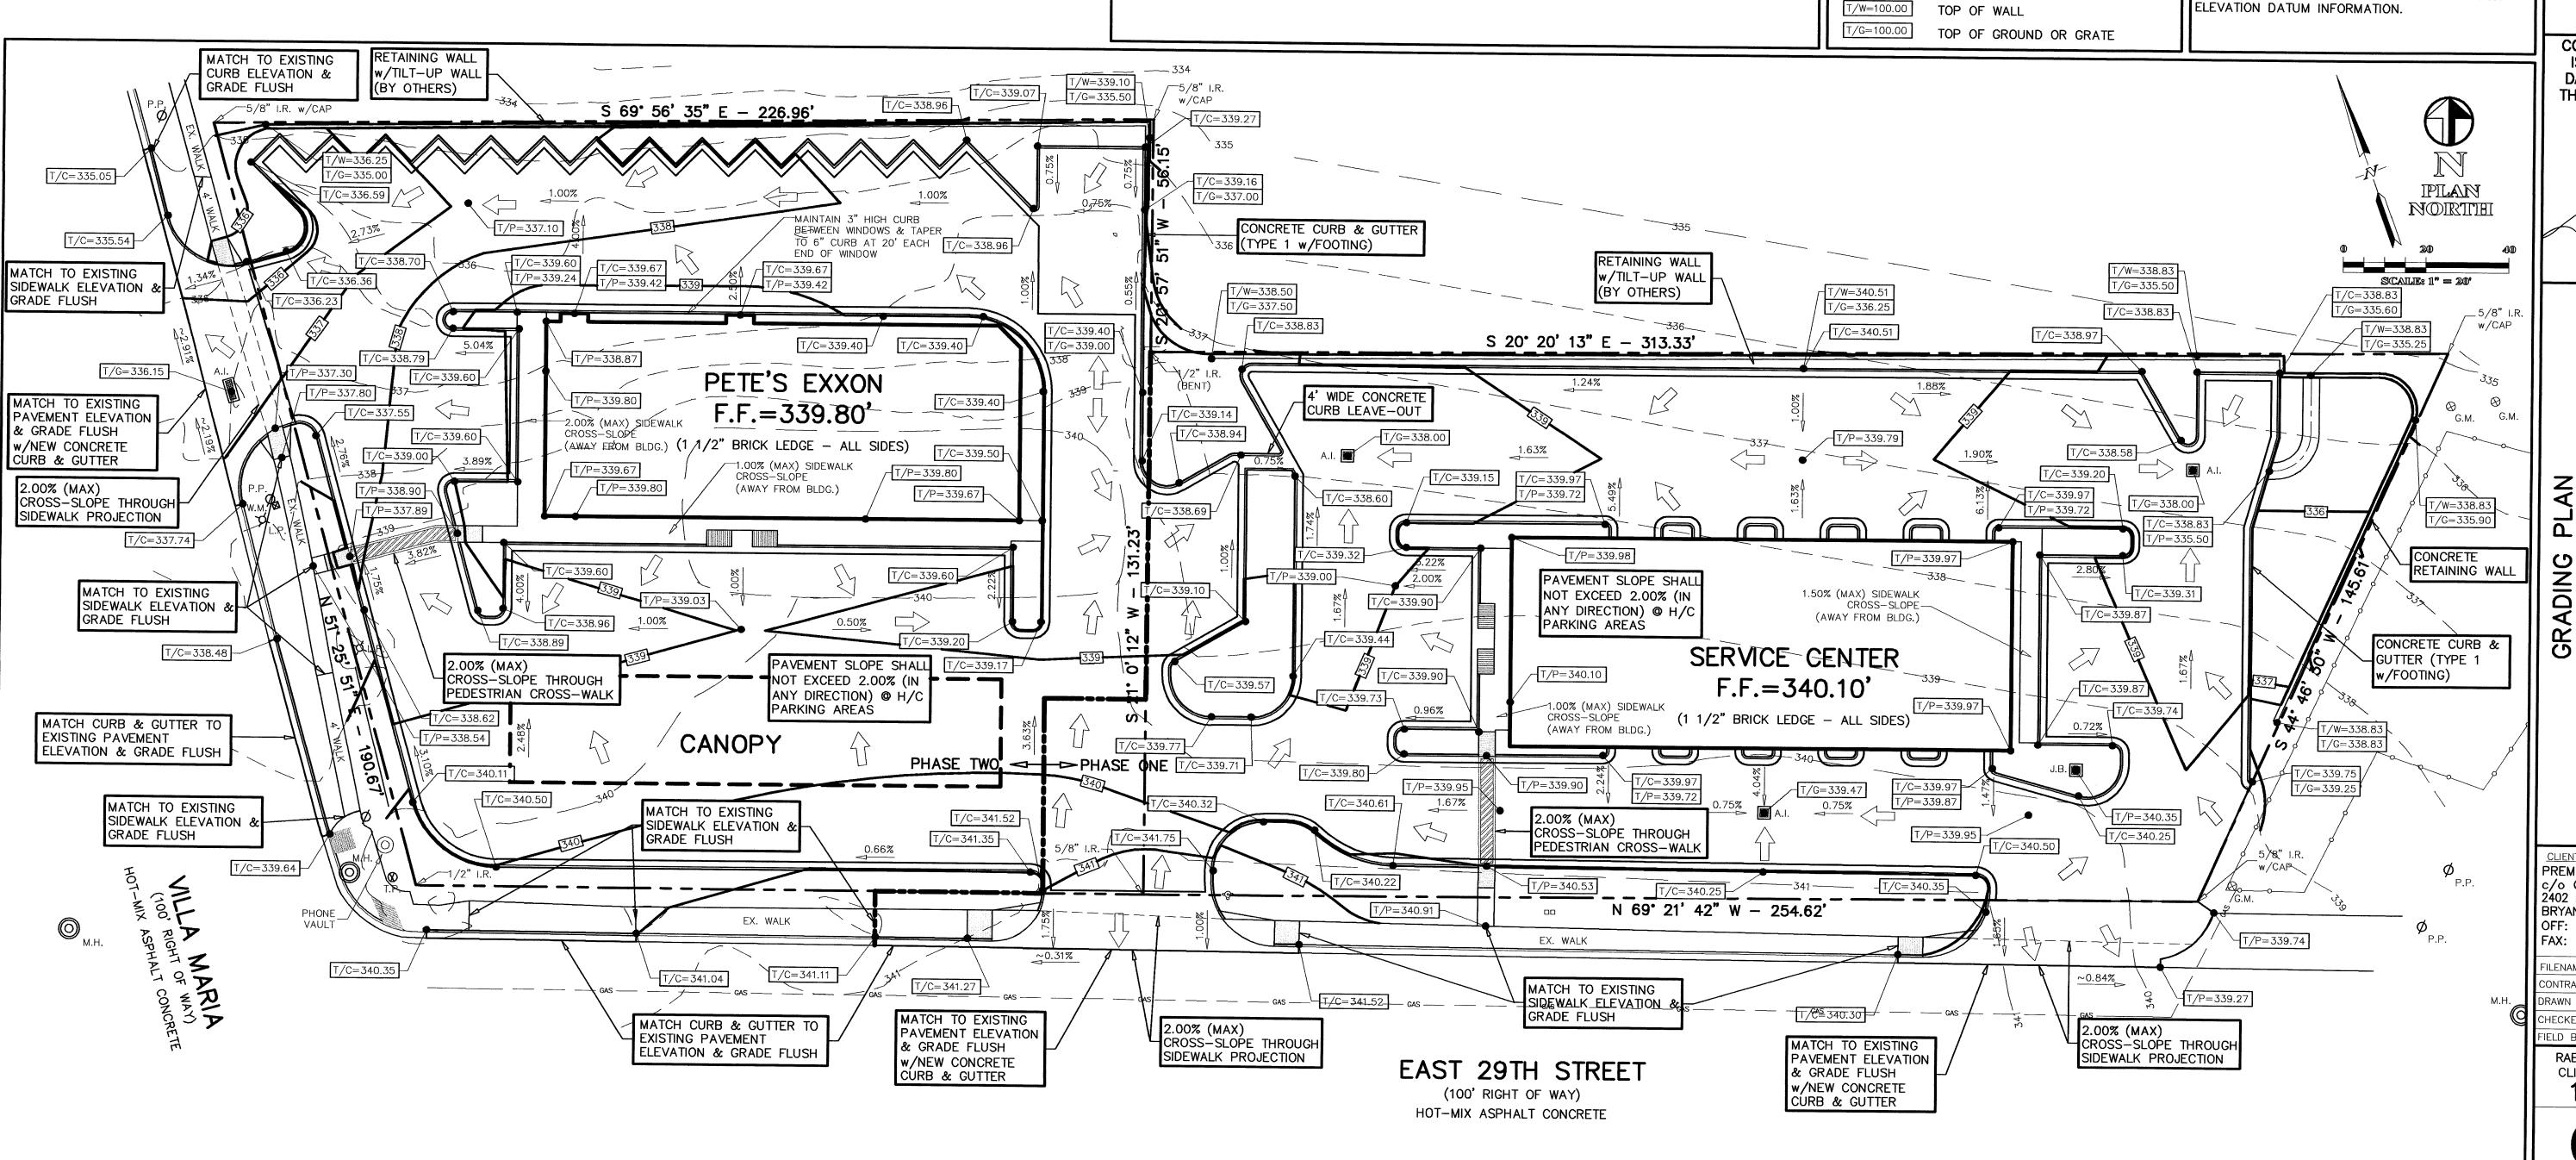

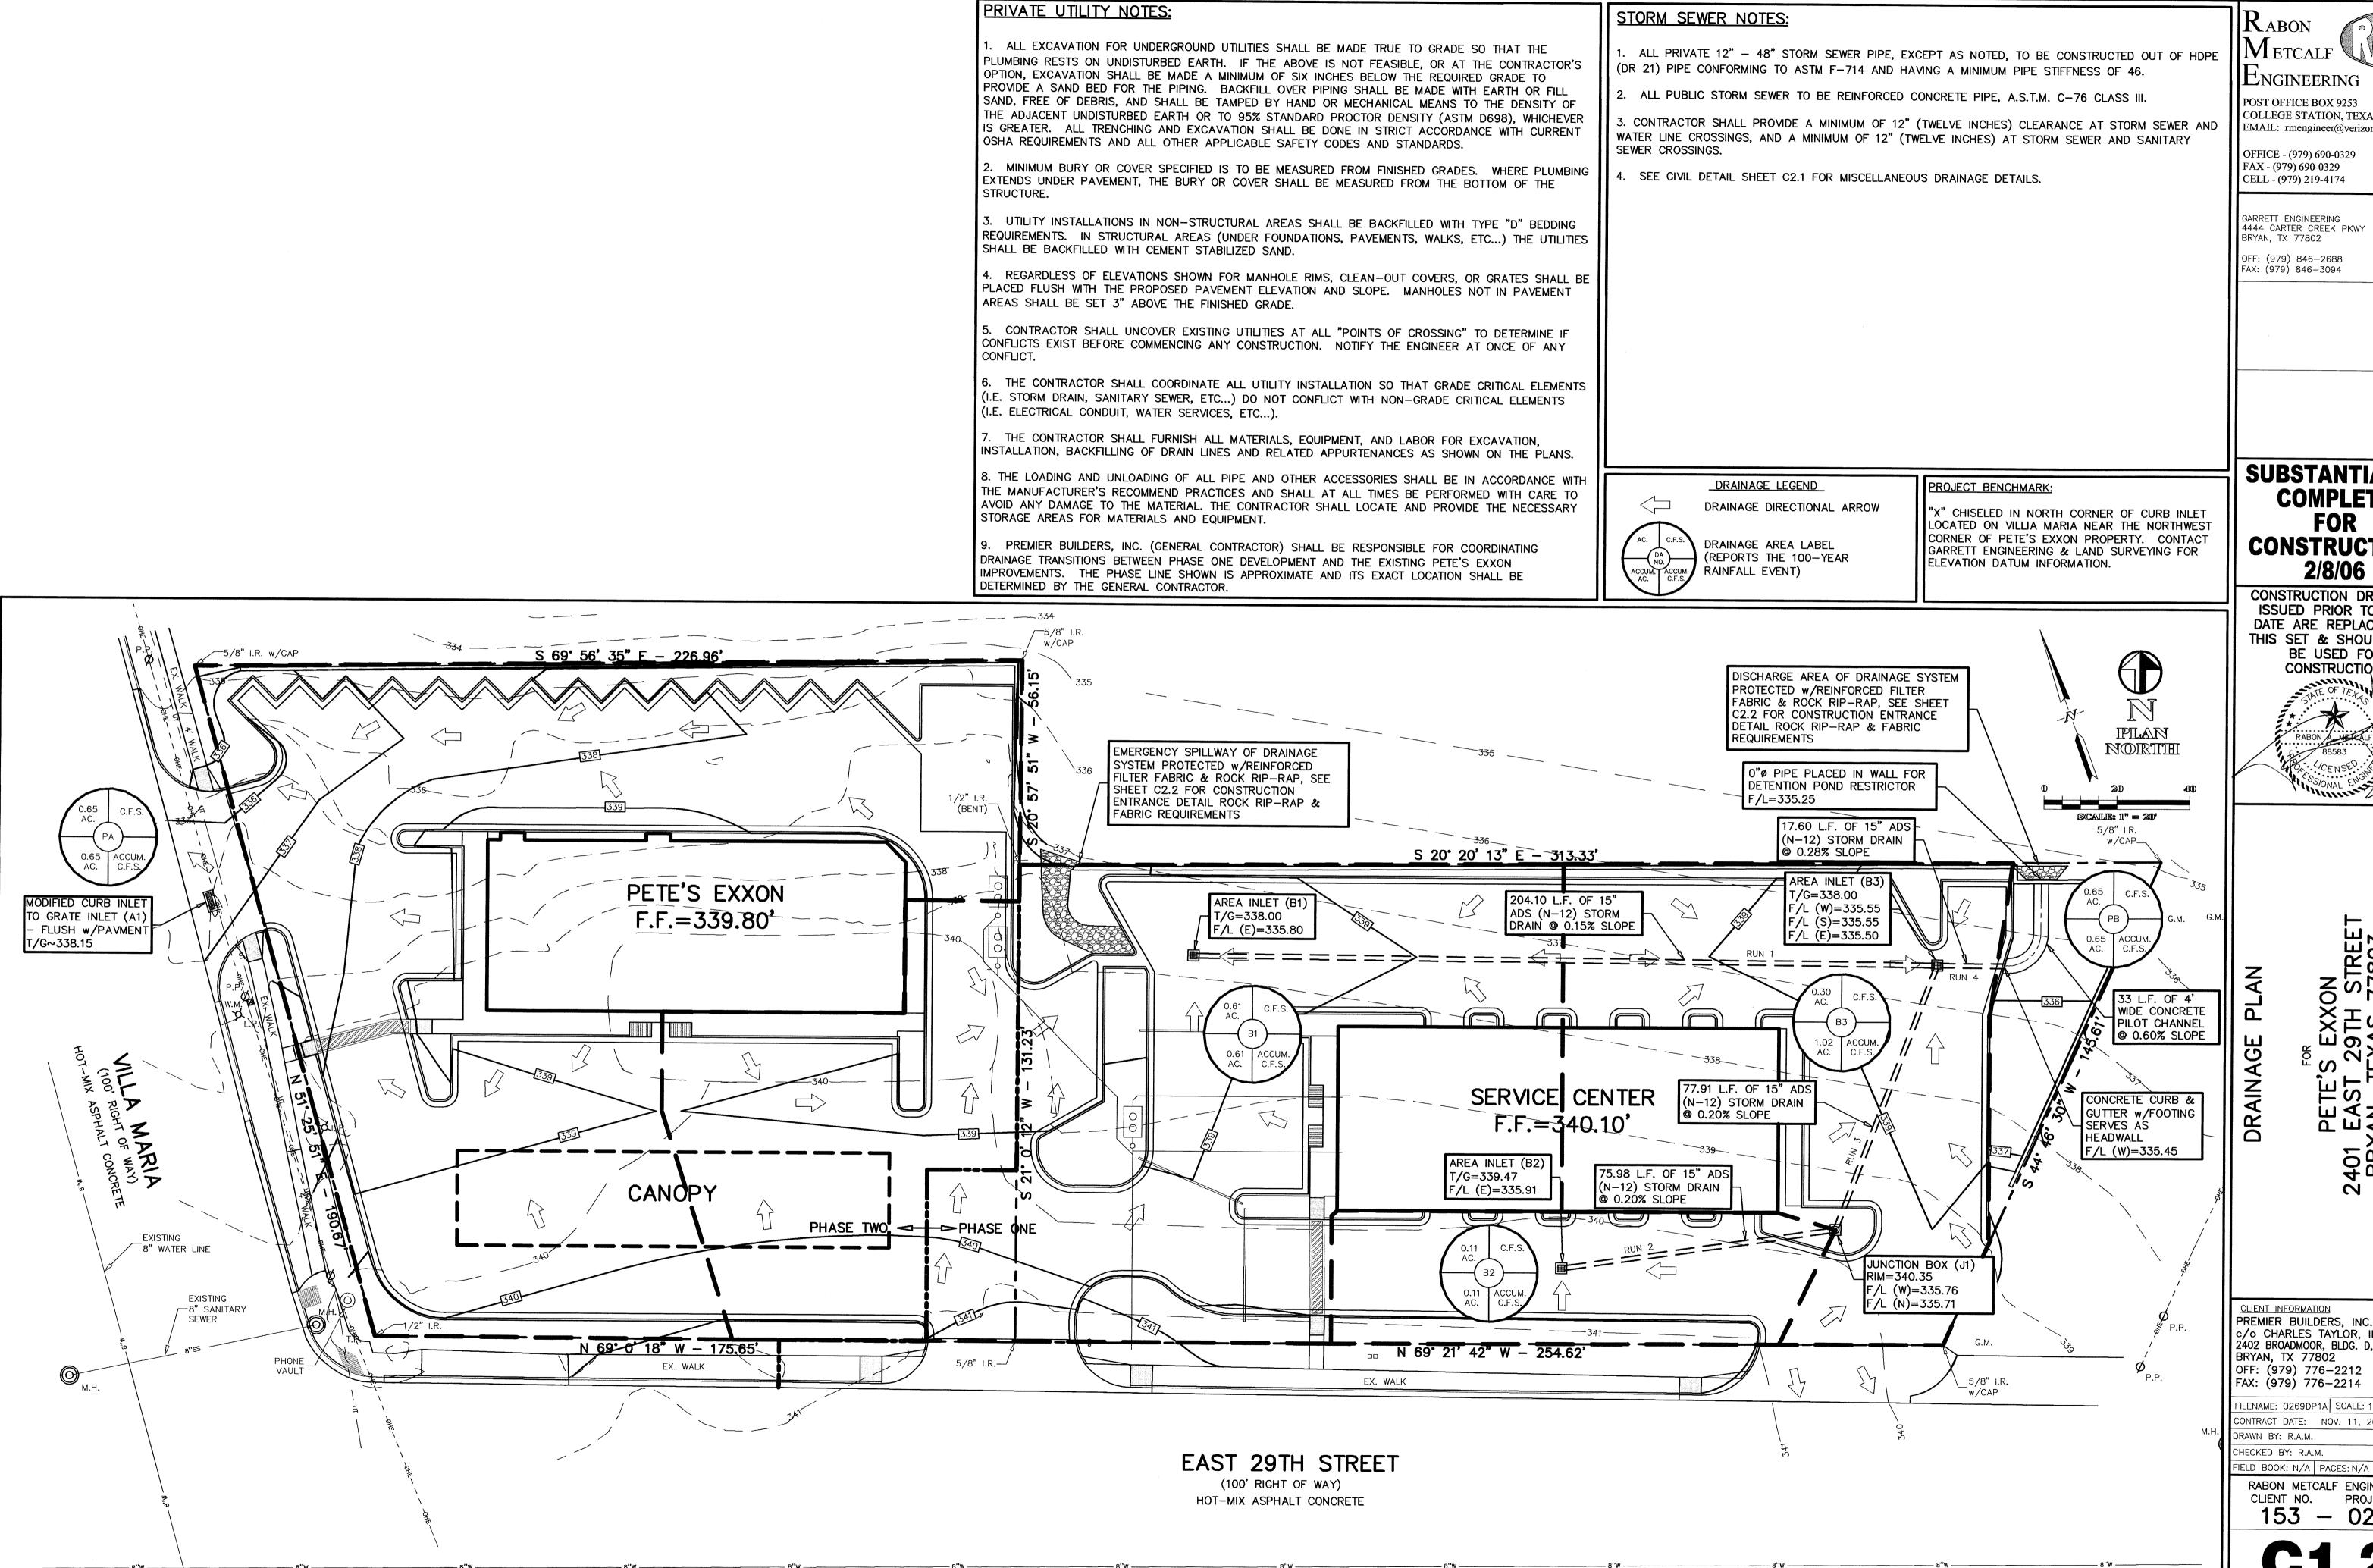

LNGINEERING POST OFFICE BOX 9253

COLLEGE STATION, TEXAS 77842 EMAIL: rmengineer@verizon.net


FAX - (979) 690-0329 CELL - (979) 219-4174

GARRETT ENGINEERING 4444 CARTER CREEK PKWY

OFF: (979) 846-2688 FAX: (979) 846-3094

## SUBSTANTIALLY COMPLETE **FOR CONSTRUCTION**

2/8/06 CONSTRUCTION DRAWINGS ISSUED PRIOR TO THIS DATE ARE REPLACED BY THIS SET & SHOULD NOT BE USED FOR CONSTRUCTION.

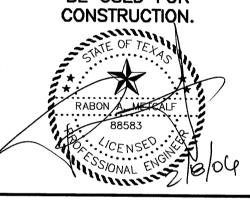

BR AND GAND


**CLIENT INFORMATION** PREMIER BUILDERS, INC. c/o CHARLES TAYLOR, III 2402 BROADMOOR, BLDG. D, STE. 101 BRYAN, TX 77802 OFF: (979) 776-2212 FAX: (979) 776-2214


FILENAME: 0269DP1A SCALE: 1" = 20' CONTRACT DATE: NOV. 11, 2005 RAWN BY: R.A.M.


CHECKED BY: R.A.M.


RABON METCALF ENGINEERING CLIENT NO. PROJECT NO. 153 - 0269

SHEET NO. 3 OF 5

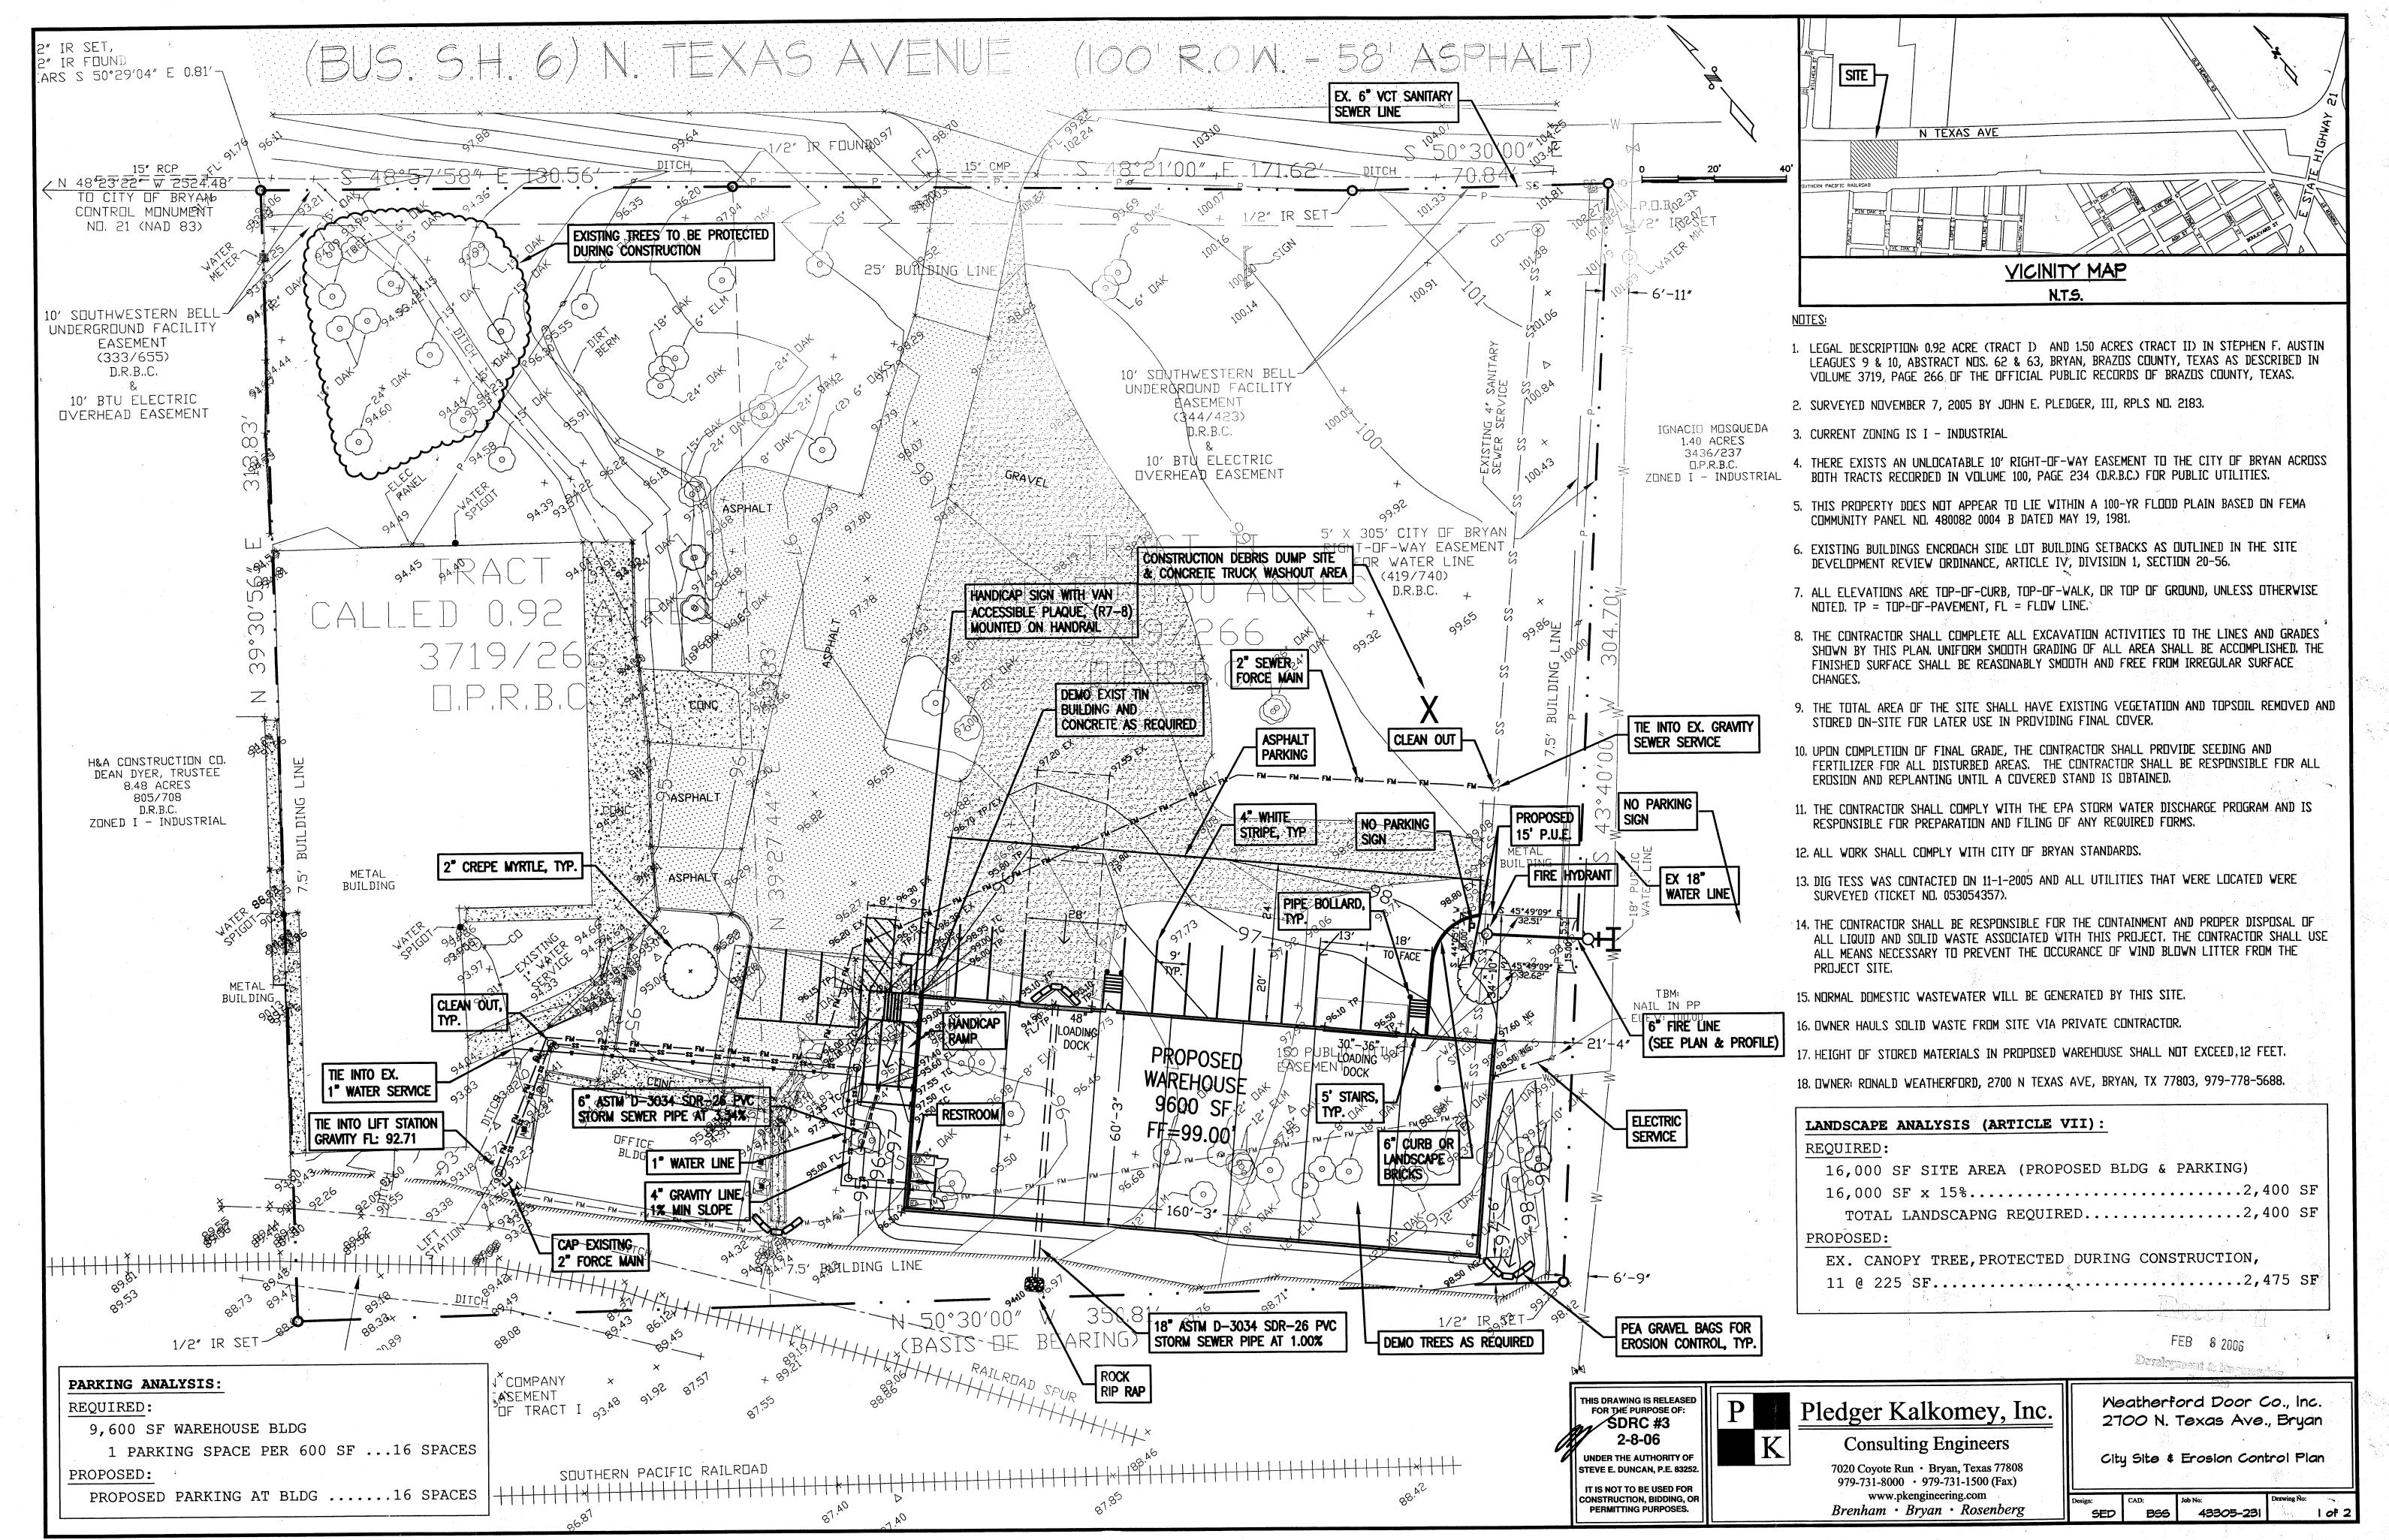

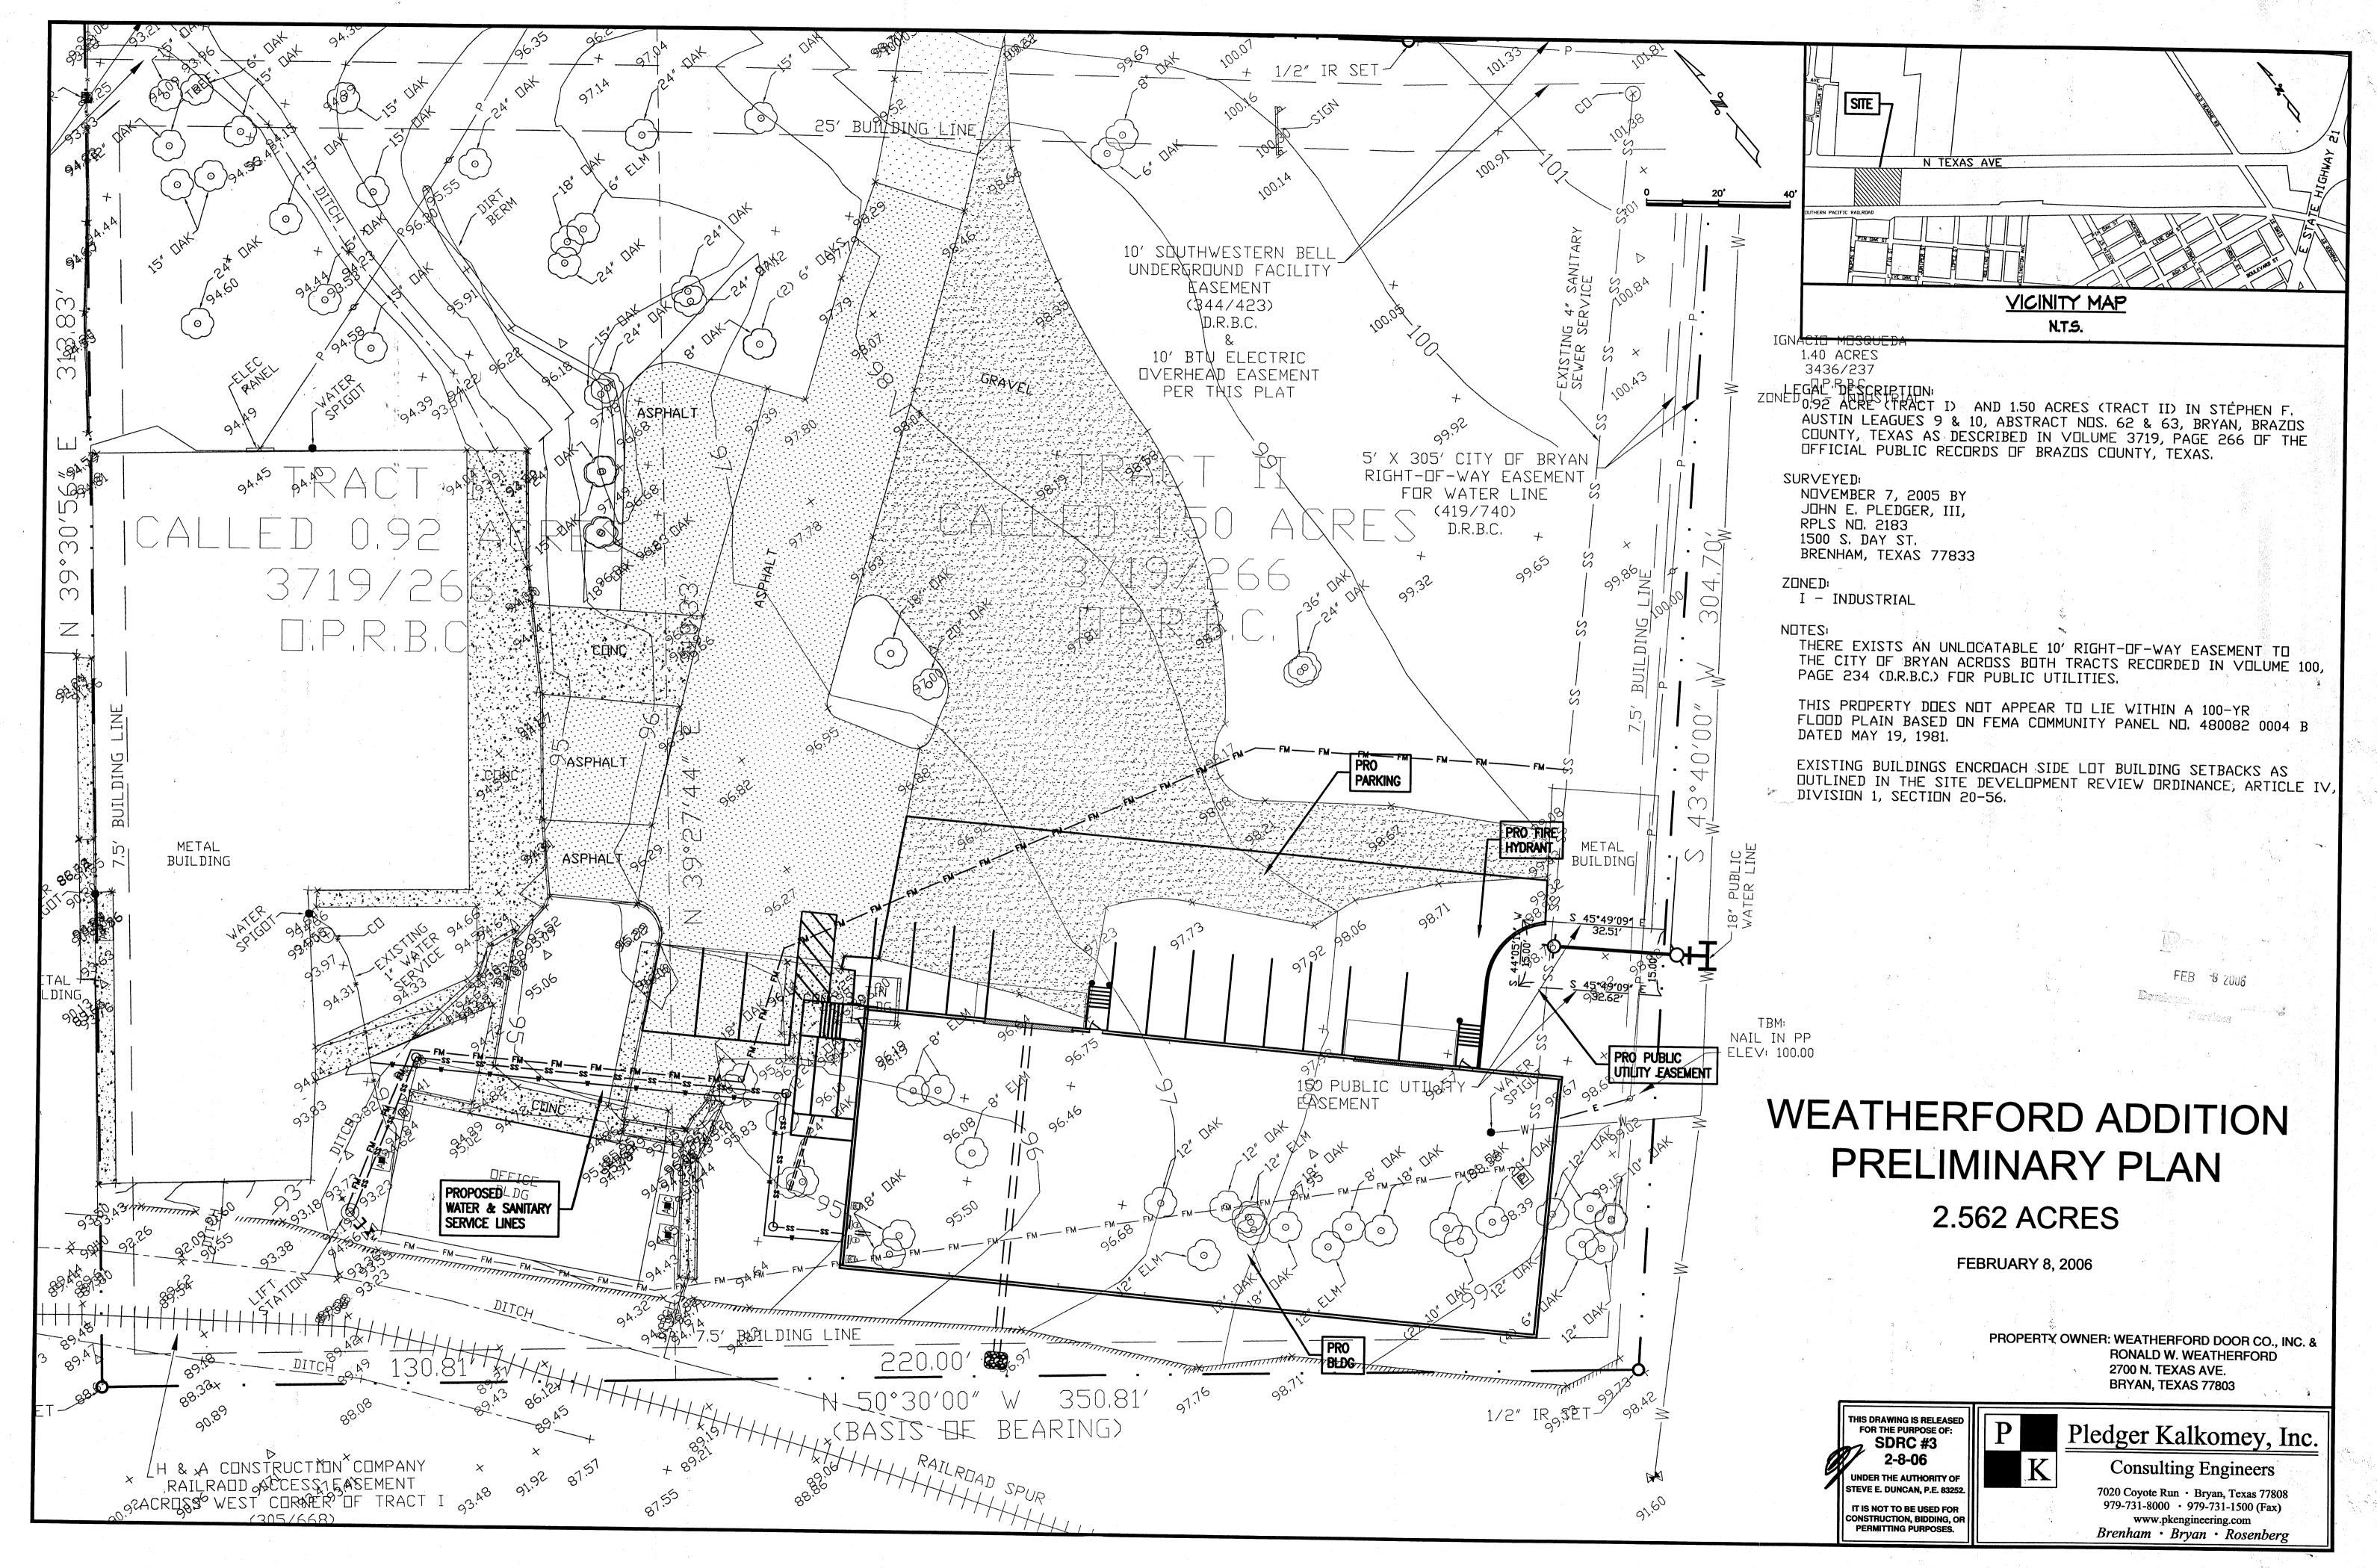

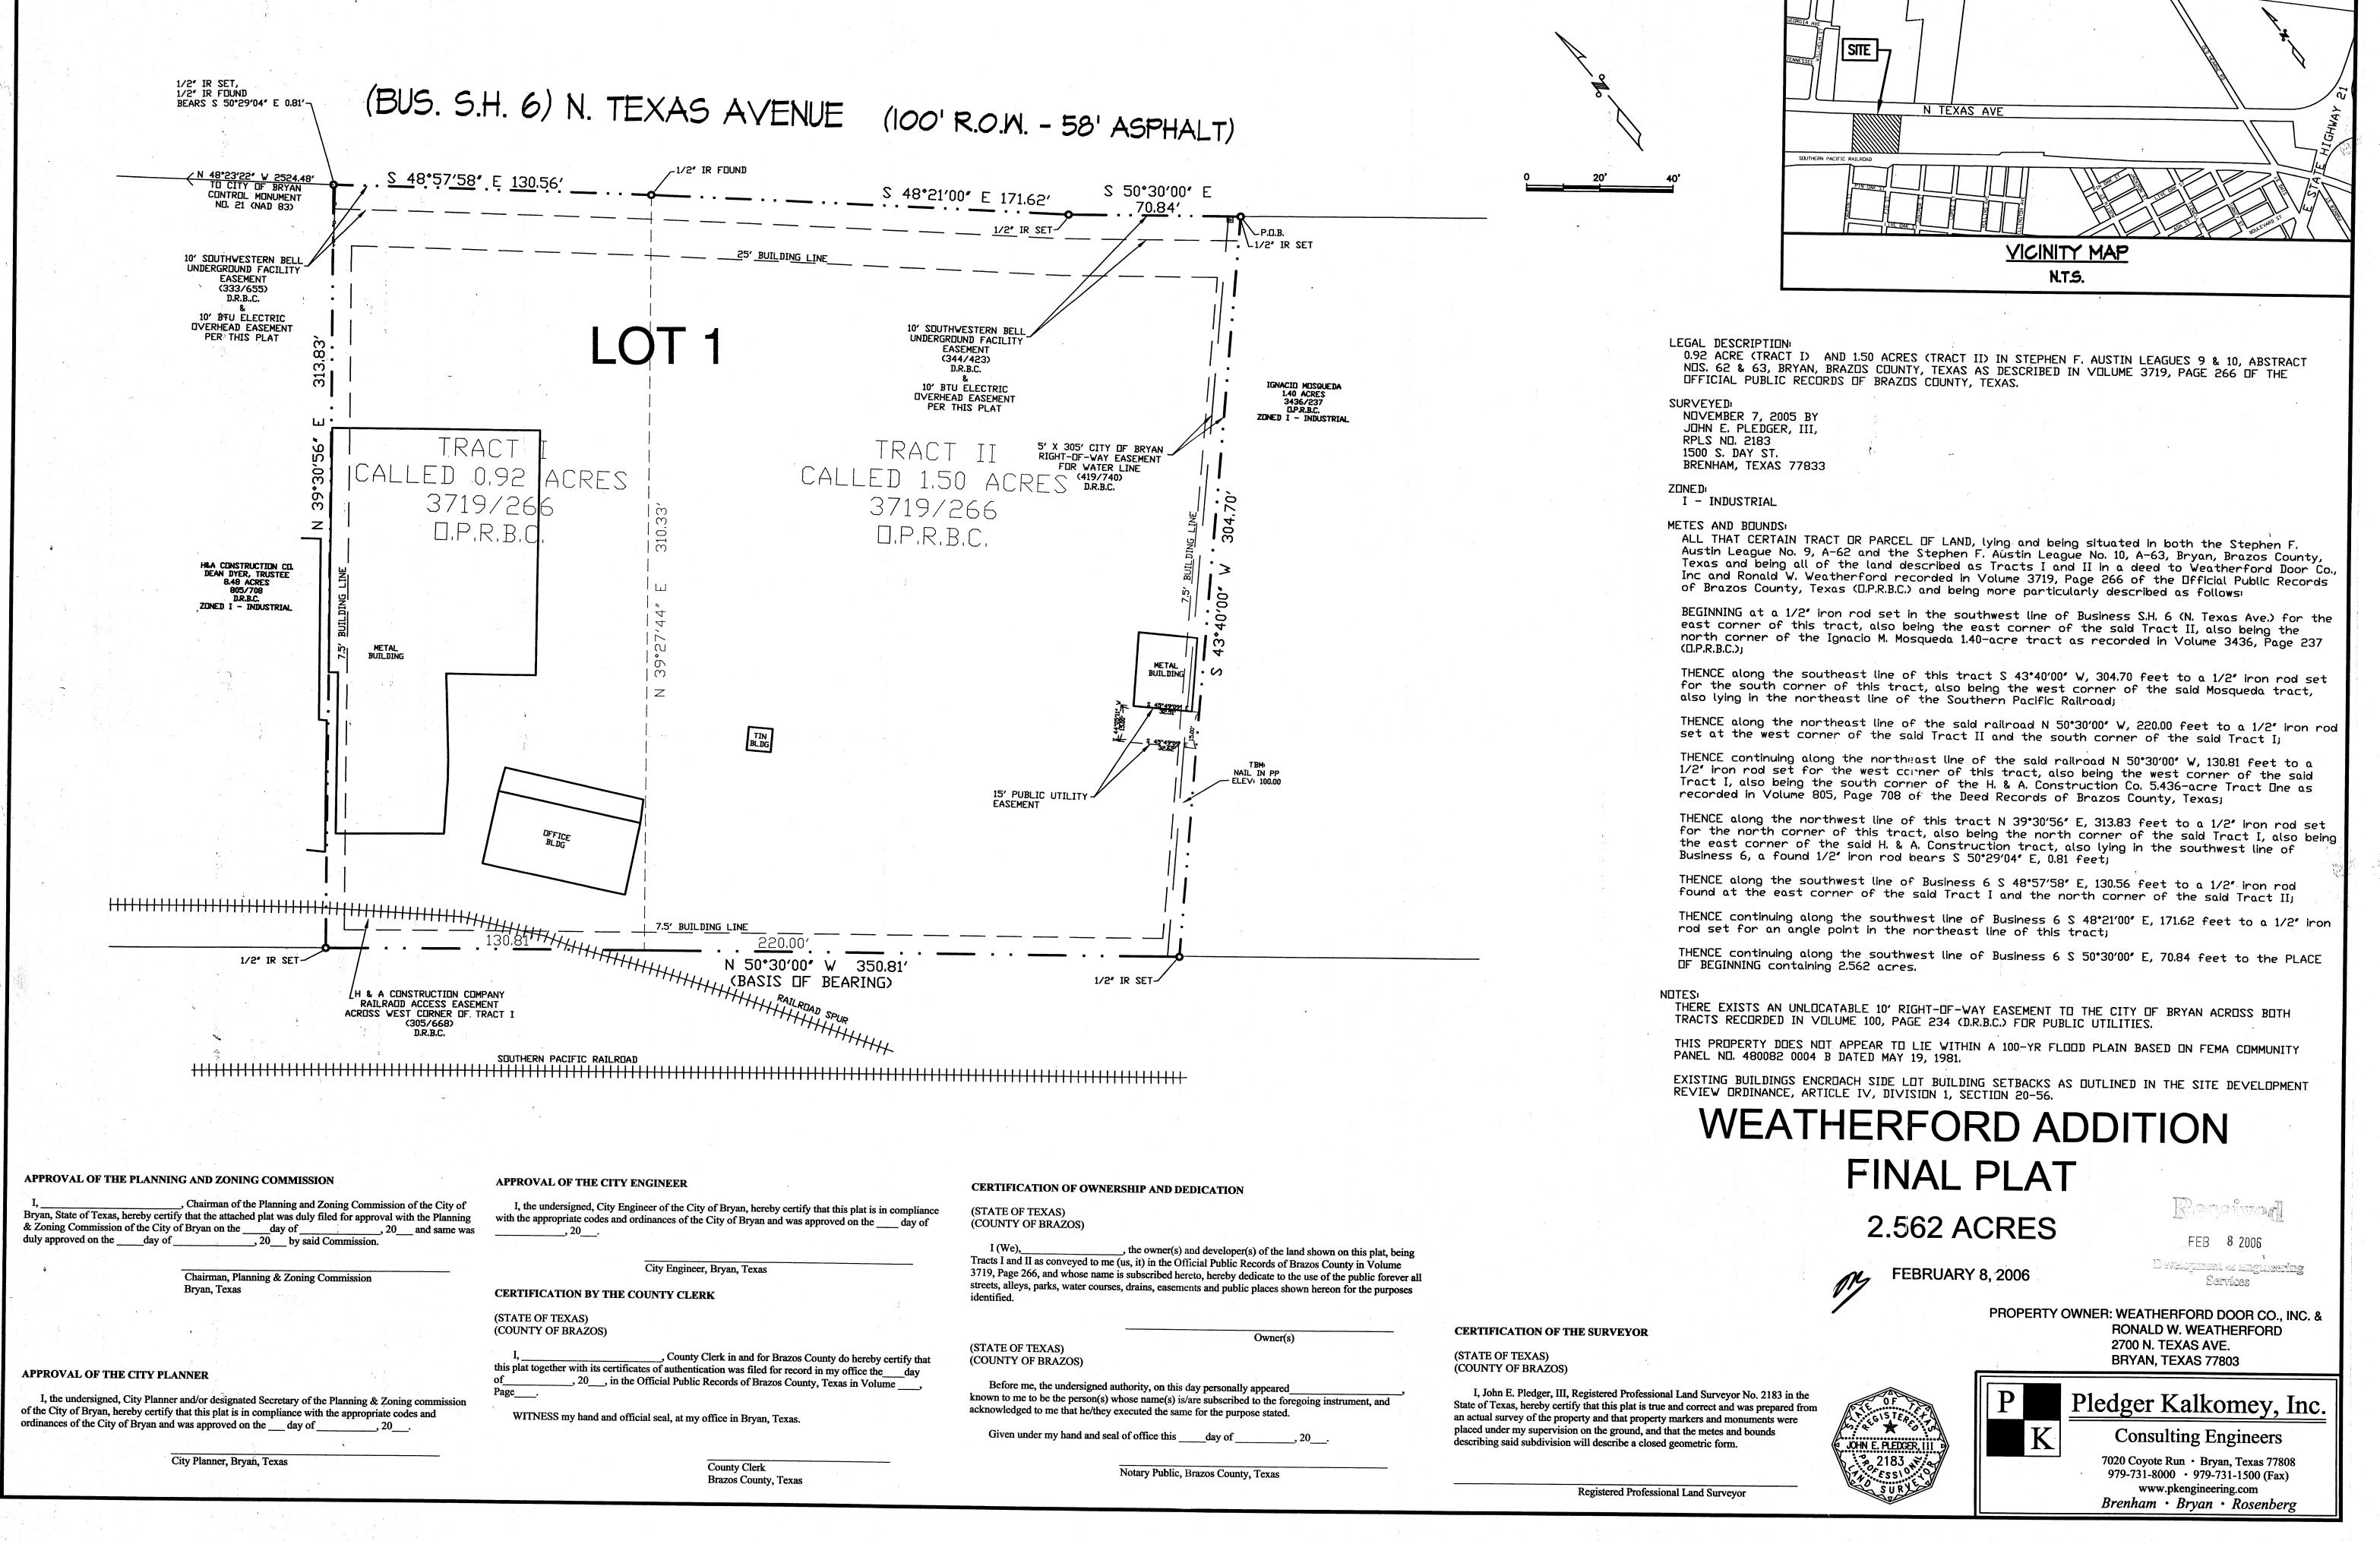

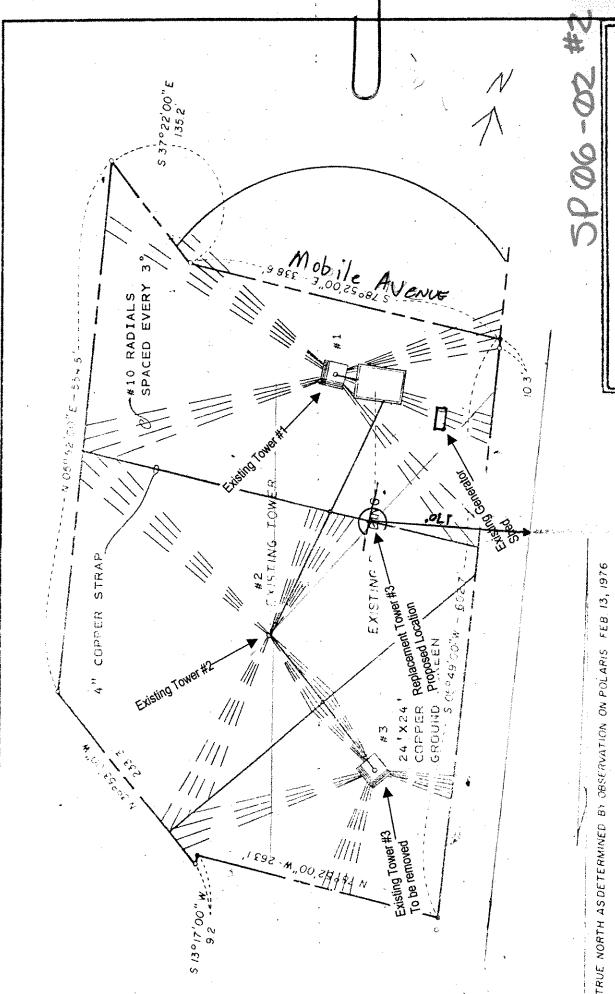

# FIGURE 2

## PLOT PLAN

RADIO BRYAN, INC. COLLEGE STATION, TEXAS

3-76

BASE MAP BY HOLLIGAN ENGINEERING

BRYAN, TEXAS


1"=100"

SCALE:

150


100

0 50

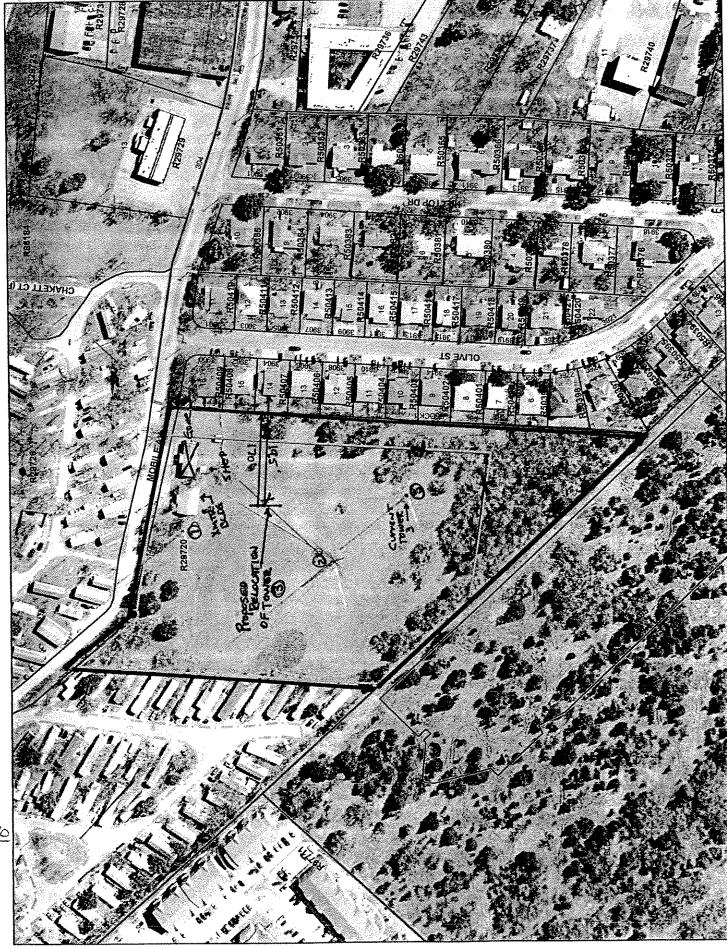

°C


#### Gas Line testing at 146 Mobile Avenue

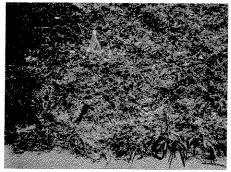

Atmos mark showing clear at edge of property. This was from the recall check of 1/26/2006.



Photo showing location of Atmos edge-of-property flag.

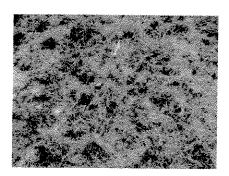

Original Atmos clear marker from test conducted during the week of December 3, 2005. Faded but still visible on site.


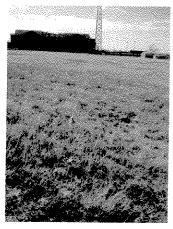



Photo showing location of Atmos original test site.

Because of the discrepancy between the Atmos records and the City records we will call Dig-Tess again and request they check the specific location of our foundation upon request approval.

MP 06-01 #2

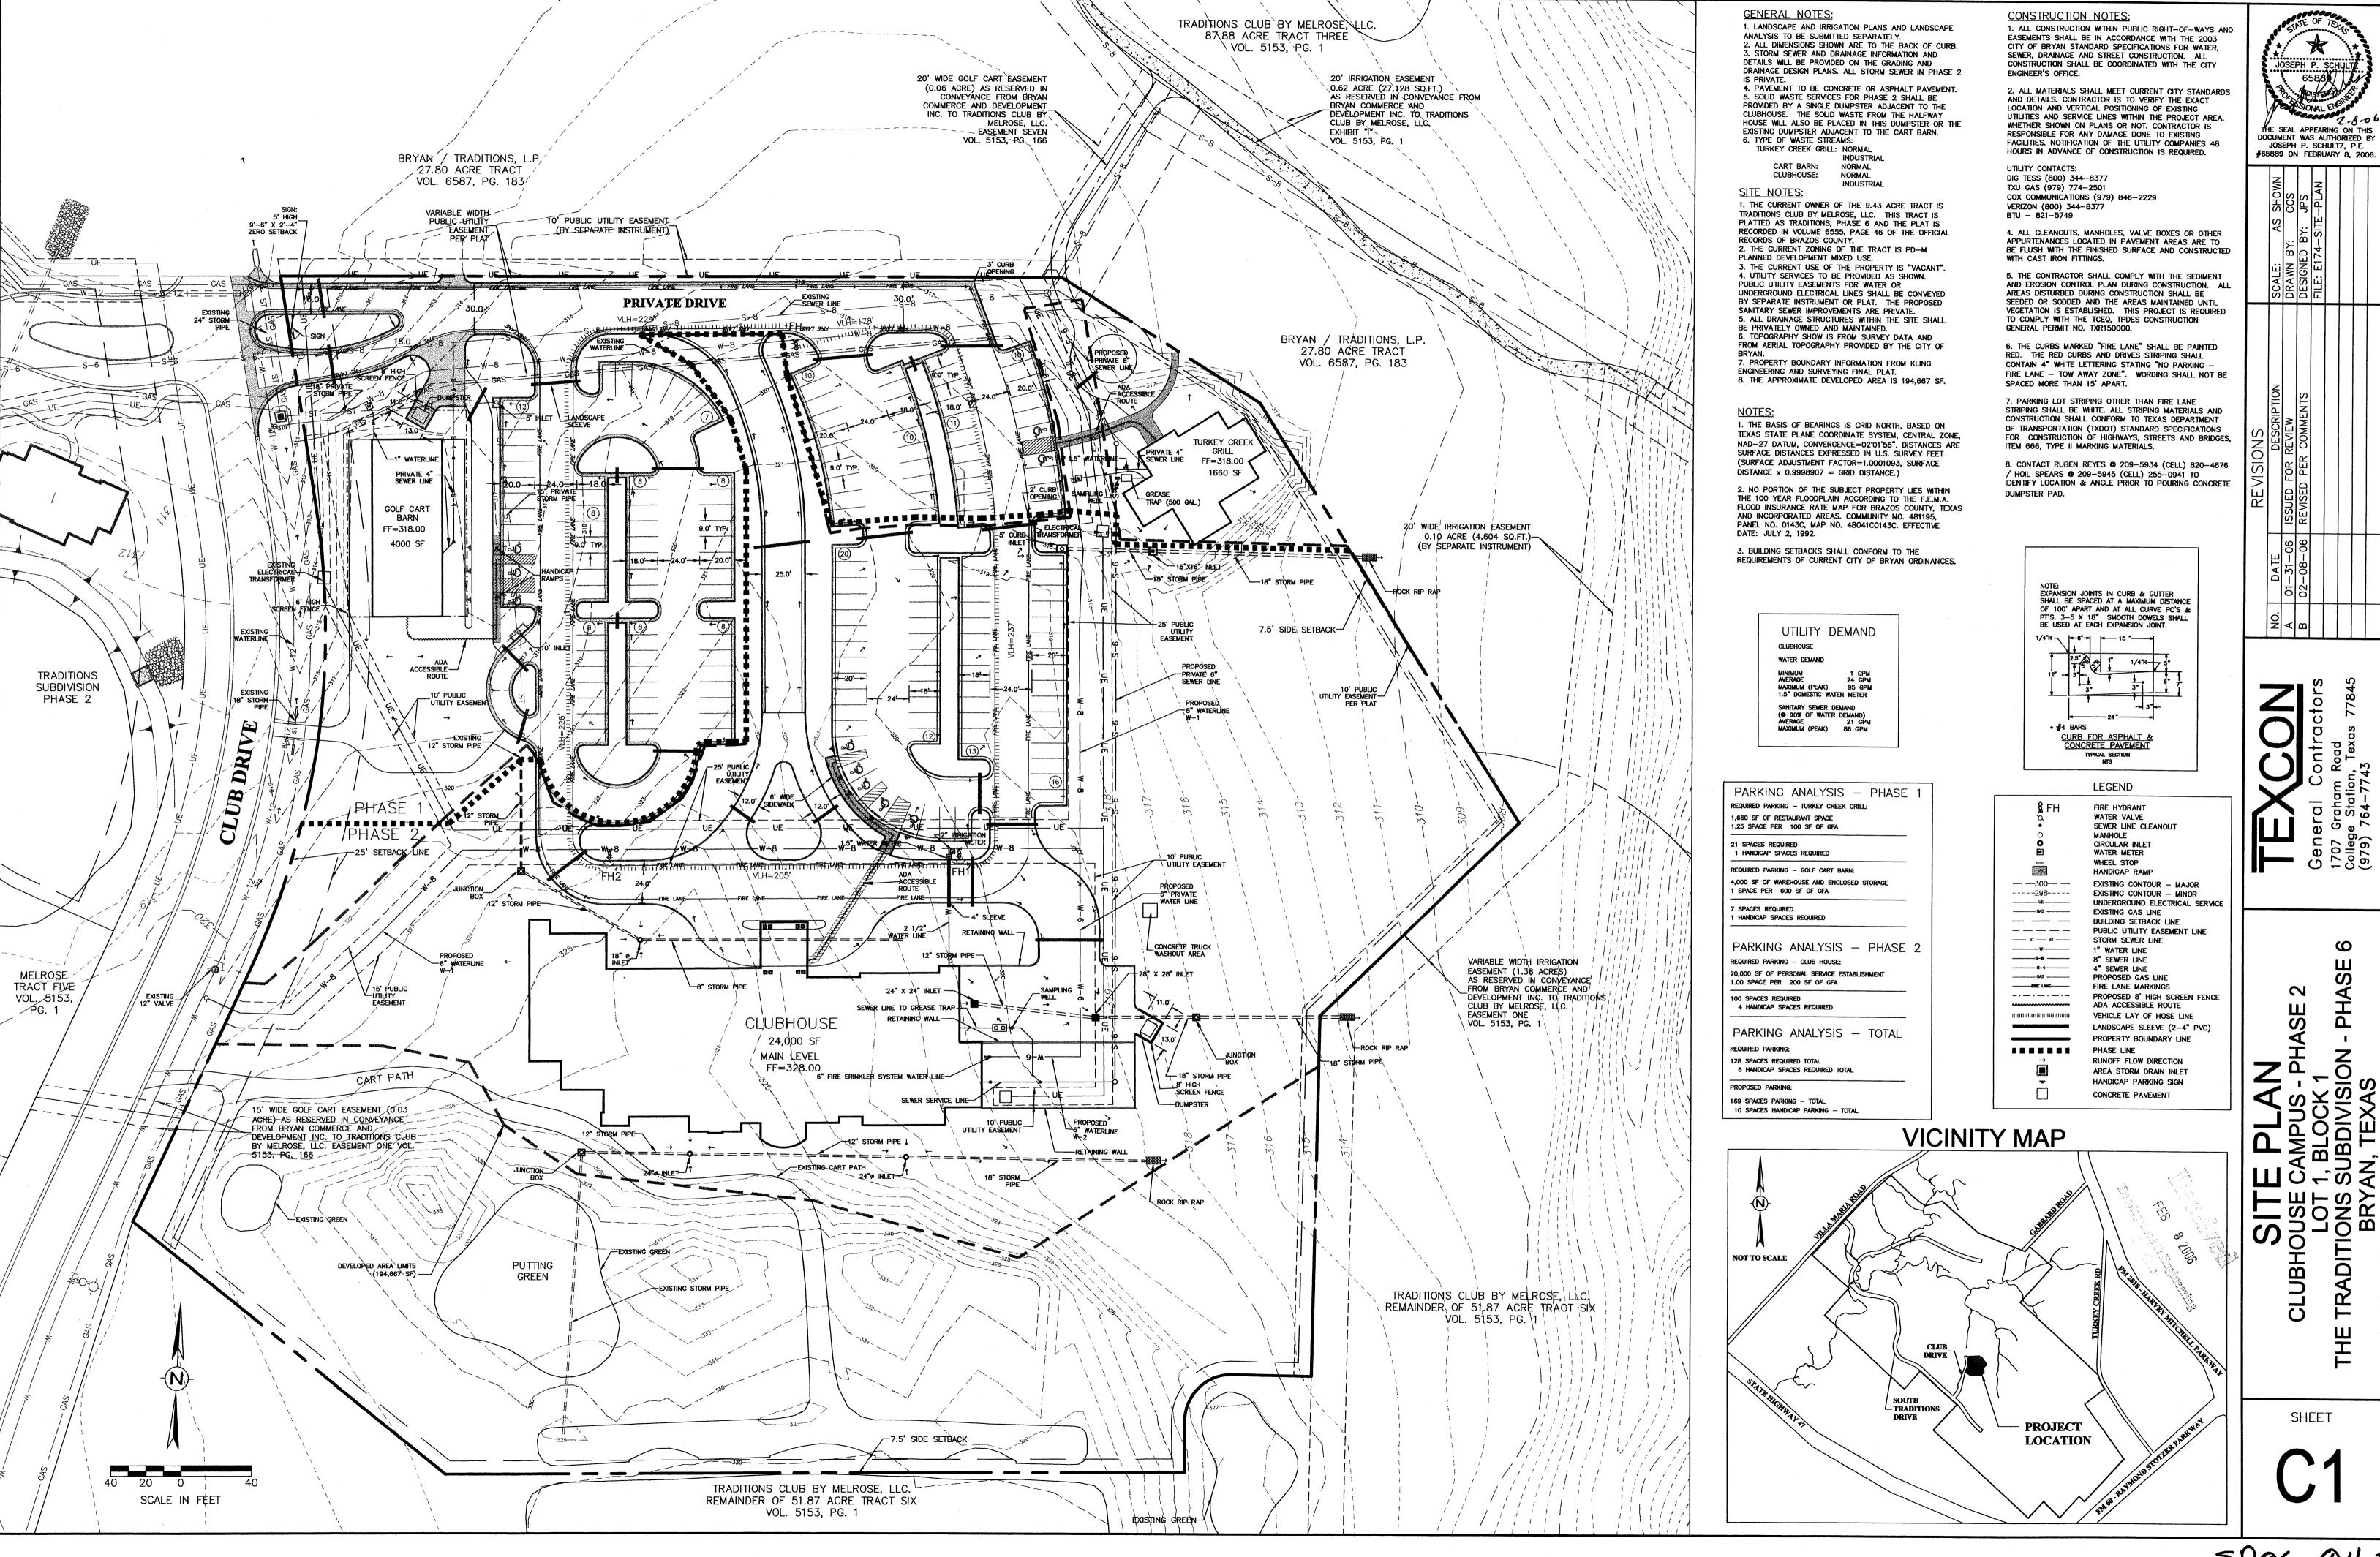

5P06-04 #Z

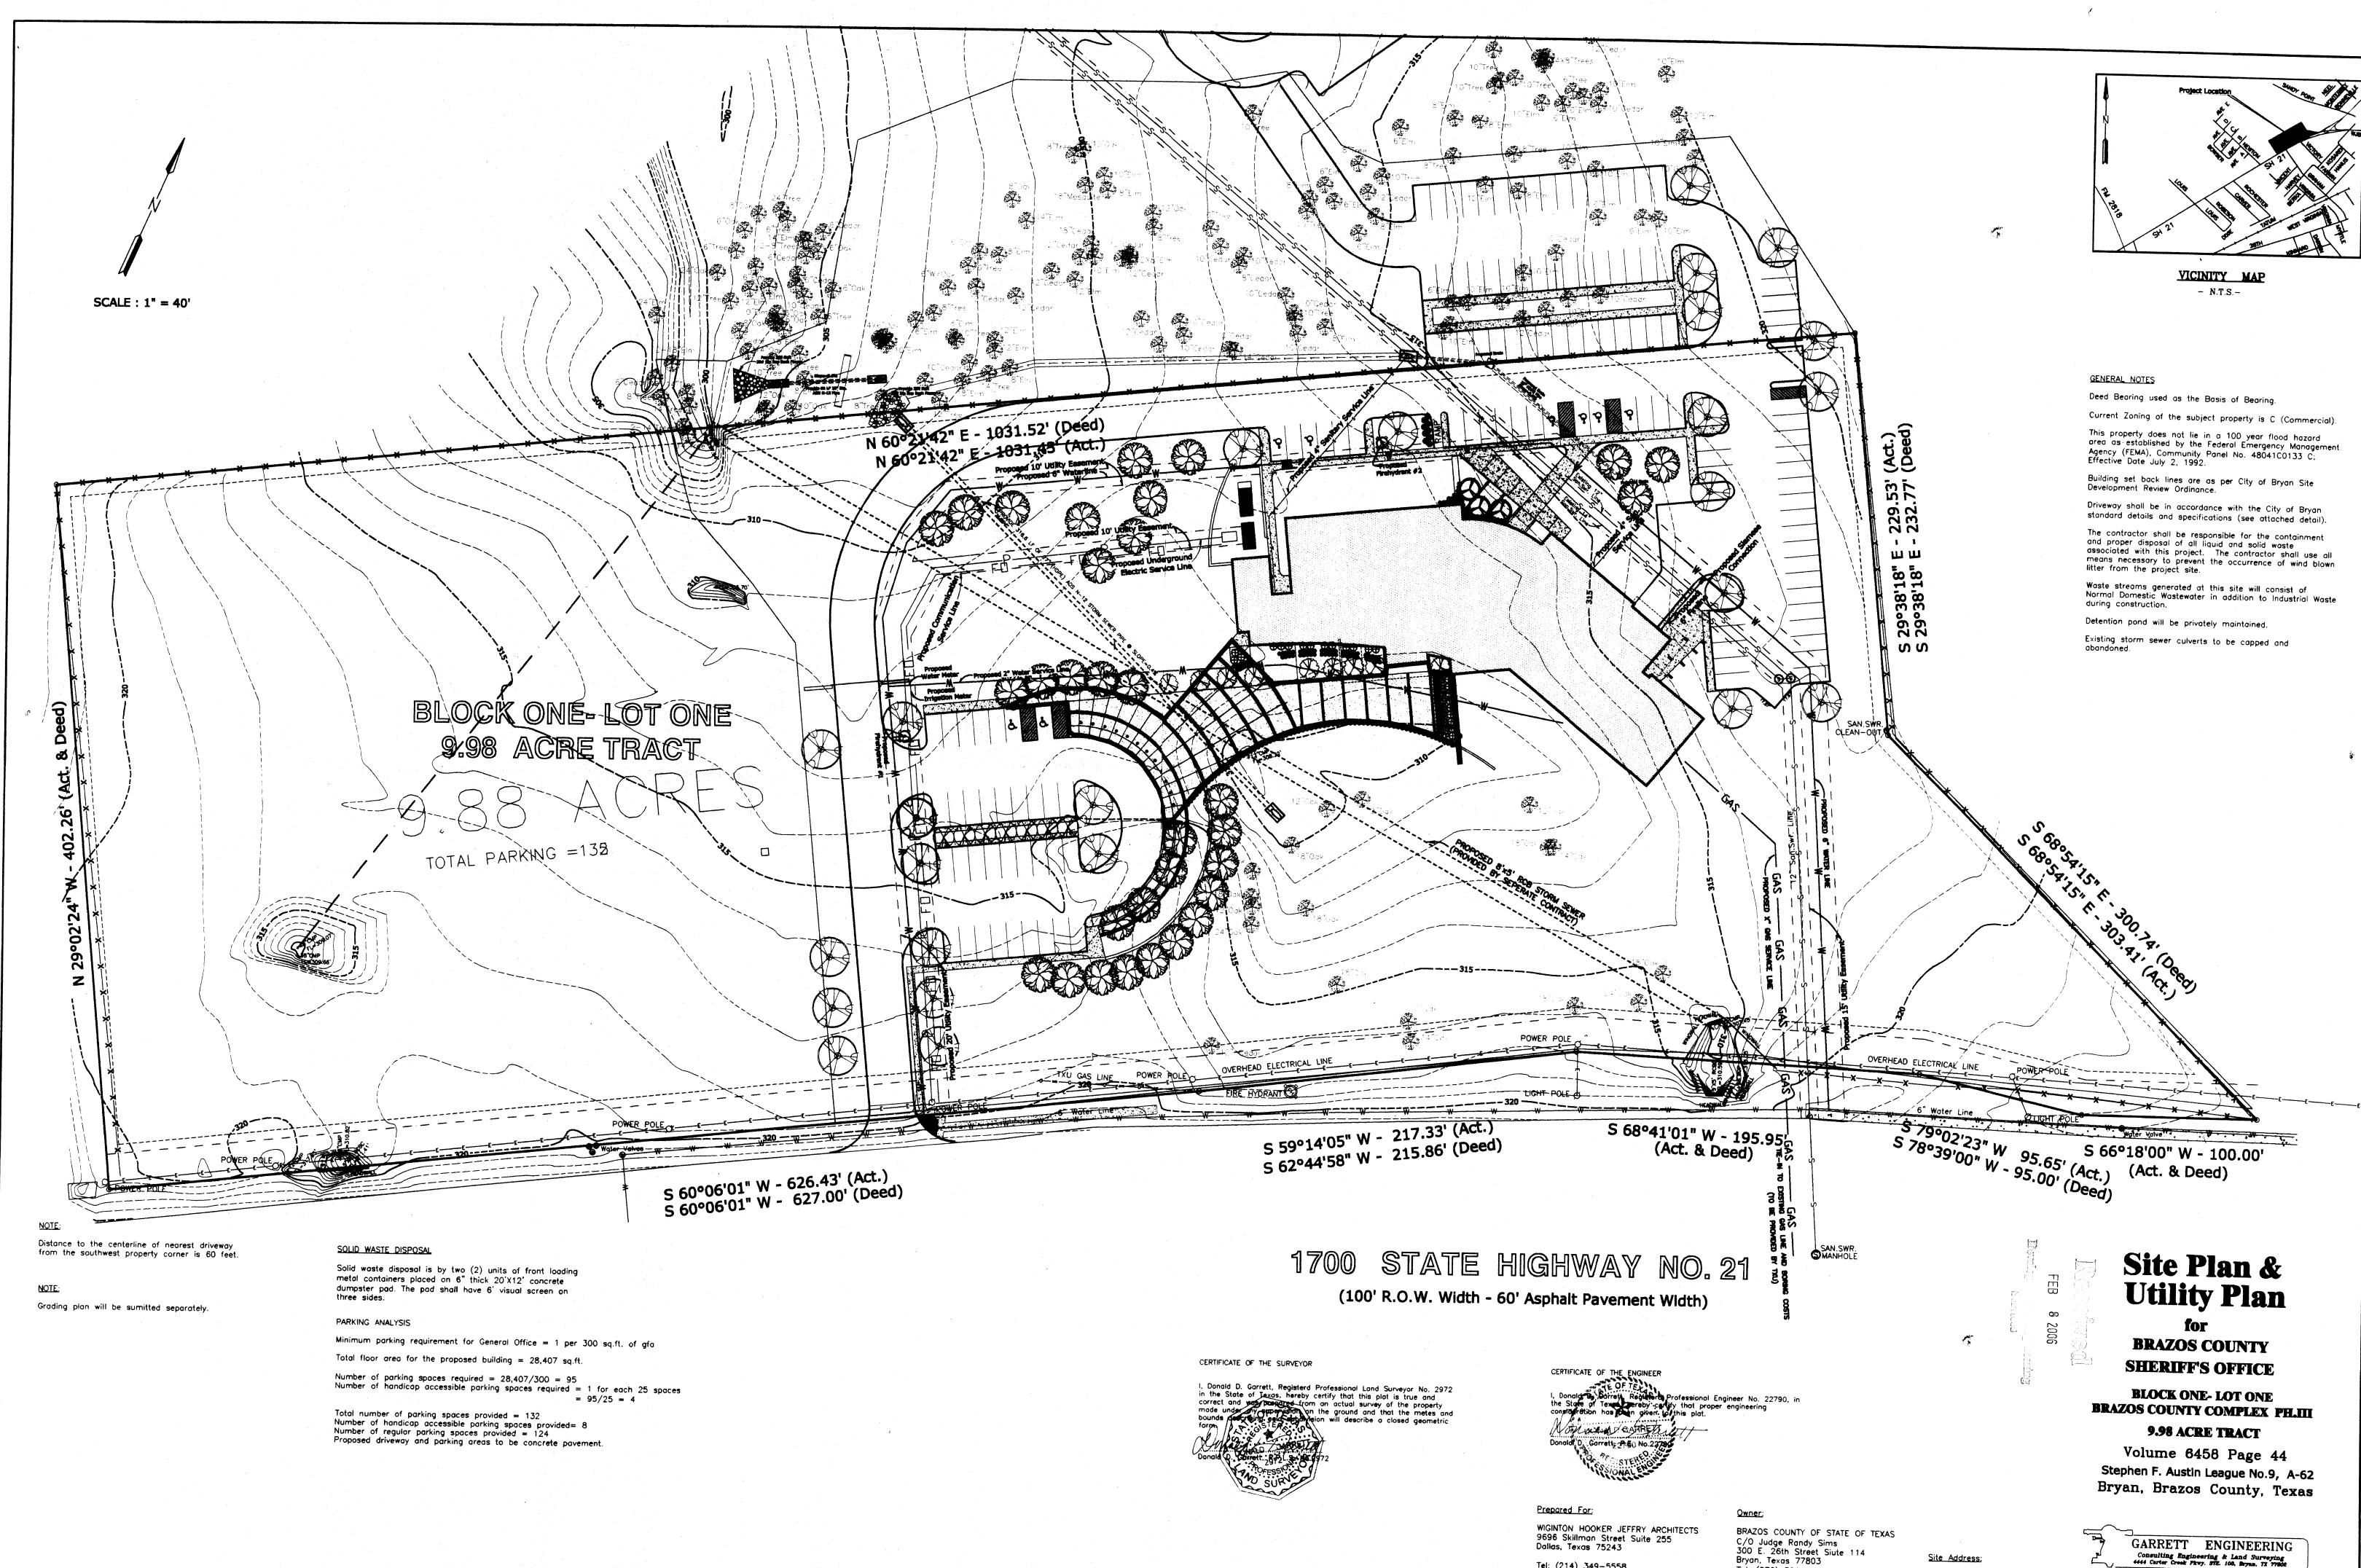

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Fox: (214) 349-2522

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